RESIDENTIAL APARTMENT DEVELOPMENT LOT 101 DP 1267563 SOMME AVENUE EDMONDSON PARK NSW

AMENDING DEVELOPMENT APPLICATION

DRAWING NO.	DRAWING NAME	REVISION	DATE
0000 SERIES: CONTEXT	, SITE + DEVELOPMENT DATA		
DA 0001	DRAWING LIST + LOCATION PLAN	С	29.02.24
DA 0002	ACCOMMODATION SCHEDULE	С	29.02.24
DA 0003	DEVELOPMENT DATA	С	29.02.24
DA 0004	CONTEXT ANALYSIS PLAN	В	29.02.24
DA 0005	SITE ANALYSIS PLAN	В	29.02.24
DA 0006	SITE PLAN	C	29.02.24
1000 SERIES: GENERAL	. ARRANGEMENT PLANS (BLD A+B)		
DA 1001	BASEMENT 2 PLAN	С	29.02.24
DA 1002	LEVEL LG (B1) PLAN - BLD A+B	С	29.02.24
DA 1003	LEVEL 1 (G) PLAN - BLD A+B	С	29.02.24
DA 1004	LEVEL 2 PLAN - BLD A+B	С	29.02.24
DA 1005	LEVEL 3 PLAN - BLD A+B	С	29.02.24
DA 1006	LEVEL 4 PLAN - BLD A+B	С	29.02.24
DA 1007	LEVEL 5 PLAN - BLD A+B	С	29.02.24
DA 1008	LEVEL 6 PLAN - BLD A+B	С	29.02.24
DA 1009	LEVEL 7 PLAN - BLD A+B	Α	29.02.24
DA 1010	ROOF PLAN - BLD A+B	Α	29.02.24
1100 SERIES: GENERAL	. ARRANGEMENT PLANS (BLD C)		
DA 1102	BASEMENT 4 PLAN - BLD C	В	29.02.24
DA 1103	BASEMENT 3 PLAN - BLD C	В	29.02.24
DA 1104	BASEMENT 2 PLAN - BLD C	В	29.02.24
DA 1105	BASEMENT 1 PLAN - BLD C	В	29.02.24
DA 1106	LEVEL 1 (G) PLAN - BLD C	В	29.02.24
DA 1107	LEVEL 2 PLAN - BLD C	C	29.02.24
DA 1108	LEVEL 3 PLAN - BLD C	C	29.02.24
DA 1109	LEVEL 4 PLAN - BLD C	C	29.02.24
DA 1110	LEVEL 5 PLAN - BLD C	C	29.02.24
DA 1111	LEVEL 6 PLAN - BLD C	В	29.02.24
DA 1112	LEVEL 7 PLAN - BLD C	В	29.02.24
DA 1113	LEVEL 8 PLAN - BLD C	A	29.02.24
DA 1114	ROOF PLAN - BLD C	A	29.02.24
2000 SERIES: ELEVATION DA 2001	NS + SECTIONS (BLD A+B) NORTH + SOUTH ELEVATION (BLD A+B)	С	29.02.24
DA 2001 DA 2002	EAST + WEST ELEVATIONS + SECTIONS (BLD A+B)	C	29.02.24
DA 2002 DA 2003	INTERNAL ELEVATIONS + SECTIONS (BLD A+B)	C	29.02.24
0400 CEDIEC, ELEVATIO	ANG A CECTIONS (DLD C)		
DA 2101	NORTH + SOUTH ELEVATION (BLD C)	В	29.02.24
DA 2101 DA 2102	NORTH + SOUTH ELEVATION (BLD C) EAST + WEST ELEVATION + SECTIONS (BLD C)	В	29.02.24
4000 CEDIEC, AEDIAL M	IFWO		
4000 SERIES: AERIAL VI DA 4001	AERIAL VIEW - NORTH	6	20 02 24
DA 4001 DA 4002	AERIAL VIEW - NORTH AERIAL VIEW - SOUTH	C C	29.02.24 29.02.24
5000 SERIES: SUN EYE		_	
DA 5001 DA 5002	SUN EYE VIEWS - WINTER SOLSTICE (09.00-12.00) SUN EYE VIEWS - WINTER SOLSTICE (13.00-15.00)	В В	29.02.24 29.02.24
DA 3002	30N ETE VIEWS - WINTER 30E3TIGE (13.00-13.00)	Б	29.02.24
8000 SERIES: DIAGRAM		0	20 02 24
DA 8001	GFA DIAGRAMS - BLD A+B (SHEET 1)	C C	29.02.24
DA 8002	GFA DIAGRAMS - BLD C (SUEET 1)		29.02.24
DA 8003	GFA DIAGRAMS - BLD C (SHEET 1)	В	29.02.24
DA 8004	GFA DIAGRAMS - BLD C (SHEET 2) SOLAR ACCESS DIAGRAMS - BLD A+B (SHEET 1)	B C	29.02.24
DA 8005 DA 8006	SOLAR ACCESS DIAGRAMS - BLD A+B (SHEET 1) SOLAR ACCESS DIAGRAMS - BLD A+B (SHEET 2)	C	29.02.24
DA 8000 DA 8007	SOLAR ACCESS DIAGRAMS - BLD C (SHEET 1)	C	29.02.24 29.02.24
DA 8007 DA 8008	SOLAR ACCESS DIAGRAMS - BLD C (SHEET 1) SOLAR ACCESS DIAGRAMS - BLD C (SHEET 2)	В	29.02.24
DA 8009	NATURAL CROSS VENTILATION - BLD A+B (SHEET 1)	С	29.02.24
DA 8009 DA 8010	NATURAL CROSS VENTILATION - BLD A+B (SHEET 1) NATURAL CROSS VENTILATION - BLD A+B (SHEET 2)	C	29.02.24
DA 8010 DA 8011	NATURAL CROSS VENTILATION - BLD C (SHEET 1)	В	29.02.24
DA 8011 DA 8012	NATURAL CROSS VENTILATION - BLD C (SHEET 1) NATURAL CROSS VENTILATION - BLD C (SHEET 2)	В	29.02.24
DA 8012 DA 8013	MAXIMUM HOB 'HEIGHT BLANKET'	C	29.02.24
DA 8013 DA 8014	ADAPTABLE + LIVABLE ACCOMMODATION DIAGRAMS (SHEET 1)	В	29.02.24
DA 8014 DA 8015	ADAPTABLE + LIVABLE ACCOMMODATION DIAGRAMS (SHEET 1) ADAPTABLE + LIVABLE ACCOMMODATION DIAGRAMS (SHEET 2)	В	29.02.24
DA 8015 DA 8016	AFFORDABLE HOUSING AREA DIAGRAM	A A	29.02.24
DA 8010 DA 8017	LANDSCAPED AREA DIAGRAMS	A	29.02.24
DA 8017 DA 8018	DEEP SOIL AREA DIAGRAMS		29.02.24
DA 8018 DA 8019	COMMUNAL OPEN SPACE DIAGRAMS	A A	29.02.24
0000 SERIES, EVTERNA	L MATERIAL C. FINICHES : COLOURS		
9000 SERIES: EXTERNA	IL MATERIALS, FINISHES + COLOURS EXTERNAL MATERIALS, FINISHES + COLOURS BOARD - BLD A	D	20.02.24
DA 9001	LA LEDINAL IVIA LEDIALO. FINIOREO † CULUURO BUARD • BLU A	В	29.02.24
DA 9001		D	20 02 24
DA 9001 DA 9002 DA 9003	EXTERNAL MATERIALS, FINISHES + COLOURS BOARD - BLD B EXTERNAL MATERIALS, FINISHES + COLOURS BOARD - BLD C	В В	29.02.24 29.02.24


A ISSUE FOR DEVELOPMENT APPLICATION 03.11.21
B AMENDMENTS INCORPORATING DEP COMMENTS 26.05.22

AMENDMENTS INCORPORATING DEP COMMENTS 26.05.22 ISSUE PRELIMINARY SKETCH DESIGN 11.01.24 ISSUE FOR FINAL SKETCH DESIGN 18.01.24 ISSUE FOR AMENDING DEVELOPMENT APPLICATION 29.02.24

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scale

RESIDENTIAL APARTMENT DEVELOPMENT

LOT 101 DP 1267563 SOMME AVENUE

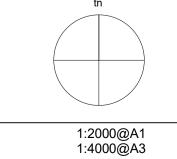EDMONDSON PARK

checked drawing DRAWING LIST + LOCATION PLAN FS issue

20 117

BUILDING	LEVEL	UNIT NO.	BEDS	TYPE	BEDS	AREA	ADAPTABLE / LIVABLE	NATURAL CROSS VENTILATION	2 HRS SOLAR ACCESS	APARTMENT STORAGE	AFFORDABLE HOUSING
Α	LEVEL 1 (G) - NORTH	A101	1B+ST	B3-2	1 BED	65 m²		YES	YES	3m³	YES
A	LEVEL 1 (G) - NORTH	A102	2B+2BA	F11-2	2 BED	82 m²		NO	YES	4m³	YES
Α	LEVEL 1 (G) - NORTH	A103	2B+2BA	F2-3	2 BED	77 m²	ADAPT/LIV	NO	YES	4m³	YES
Α	LEVEL 1 (G) - NORTH	A104		F10	2 BED	84 m²		NO	YES	4m³	YES
Α	LEVEL 1 (G) - NORTH	A105	2B	F18	2 BED	75 m²		YES	NO	4m³	YES
A	LEVEL 1 (G) - NORTH	A106	1B+ST	B6	1 BED	59 m²		NO	NO	3m³	YES
6						442 m²					
A	LEVEL 2 - NORTH	A201		B3-1	1 BED	65 m²		YES	YES	3m³	YES
A	LEVEL 2 - NORTH	A202		F11-1	2 BED	80 m²		NO	YES	4m³	YES
A	LEVEL 2 - NORTH	A203		F2-2	2 BED	77 m²	ADAPT/LIV	NO	YES	4m³	YES
A	LEVEL 2 - NORTH	A204	1B	B1	1 BED	53 m ²	LIV	NO	YES	3m³	YES
A	LEVEL 2 - NORTH	A205	2B+2BA	F4	2 BED	82 m²		YES	YES	4m³	YES
A	LEVEL 2 - NORTH	A206	3B	J1	3 BED	93 m²		YES	NO	5m³	YES
Α	LEVEL 2 - NORTH	A207	1B	B5	1 BED	51 m²		YES	YES	3m³	YES
7						502 m ²					
A	LEVEL 3 - NORTH	A301	1B+ST	B3-1	1 BED	65 m²		YES	YES	3m³	YES
Α	LEVEL 3 - NORTH	A302	2B+2BA	F11-1	2 BED	80 m²		NO	YES	4m³	YES
A	LEVEL 3 - NORTH	A303	2B+2BA	F2-2	2 BED	77 m²	ADAPT/LIV	NO	YES	4m³	YES
A	LEVEL 3 - NORTH	A304	1B	B1	1 BED	53 m²	LIV	YES	YES	3m³	YES
A	LEVEL 3 - NORTH	A305	2B+2BA	F4	2 BED	82 m²		YES	YES	4m³	YES
A	LEVEL 3 - NORTH	A306	3B	J1	3 BED	93 m²		YES	NO	5m³	YES
A	LEVEL 3 - NORTH	A307	1B	B5	1 BED	51 m²		YES	YES	3m³	YES
7						502 m ²					
Α	LEVEL 4 - NORTH	A401	1B+ST	B3-1	1 BED	65 m²		YES	YES	3m³	YES
A	LEVEL 4 - NORTH	A402		F11-1	2 BED	80 m²		YES	YES	4m³	YES
A	LEVEL 4 - NORTH	A403	2B+2BA	F2-2	2 BED	77 m²	ADAPT/LIV	YES	YES	4m³	YES
A	LEVEL 4 - NORTH	A404	1B	B1	1 BED	53 m²	LIV	YES	YES	3m³	YES
A	LEVEL 4 - NORTH	A405	2B+2BA	F4	2 BED	82 m²		YES	YES	4m³	YES
A	LEVEL 4 - NORTH	A406	3B	J1	3 BED	93 m²		YES	YES	5m³	YES
A	LEVEL 4 - NORTH	A407	1B	B5	1 BED	51 m²		YES	YES	3m³	YES

					A		MODATION SCHE	DULE - BUILDING B			
UILDING	LEVEL	UNIT NO.	BEDS	TYP E	BEDS	AREA	ADAPTABLE / LIVABLE	NATURAL CROSS VENTILATION	2 HRS SOLAR ACCESS	APARTMENT STORAGE	AFFORDABLE HOUSING
	LEVEL LG (B1) - NORTH	B001	1B	В9	1 BED	56 m²		NO	NO	3m³	NO
	LEVEL LG (B1) - NORTH	B002	3B	J6	3 BED	95 m²		YES	NO	5m³	NO
	LEVEL LG (B1) - NORTH	B003	1B	B7	1 BED	67 m ² 218 m ²		YES	NO	3m³	NO
						210111					
	LEVEL 1 (G) - NORTH	B101	3B	J2-2	3 BED	105 m²		YES	NO	5m³	NO
	LEVEL 1 (G) - NORTH LEVEL 1 (G) - NORTH	B102 B103	2B+2BA 2B+2BA	F5-2 F1-1	2 BED 2 BED	89 m² 82 m²		YES YES	YES YES	4m³ 4m³	NO NO
	LEVEL 1 (G) - NORTH	B103	2B+2BA	F2-1	2 BED	78 m ²		NO	YES	4m³	NO
	LEVEL 1 (G) - NORTH	B105	1B	B1-1	1 BED	51 m²	LIV	NO	YES	3m³	NO
	LEVEL 1 (G) - NORTH	B106	2B	B14	1 BED	70 m²	ADAPT/LIV	YES	YES	3m³	NO
	LEVEL 1 (G) - NORTH LEVEL 1 (G) - NORTH	B107 B108	2B+2BA 2B+2BA	F3-1 F17	2 BED 2 BED	77 m ² 83 m ²		NO YES	NO NO	4m³ 4m³	NO NO
	LEVEL 1 (G) - NORTH	B110	2B+2BA	F3-2	2 BED	81 m ²		NO	NO	4m³	NO
	LEVEL 1 (G) - NORTH	B111	2B	F6-2	2 BED	78 m²		YES	YES	4m³	NO
						794 m²					
	LEVEL 2 - NORTH	B201	3B	J2-1	3 BED	105 m²	LIV	YES	YES	5m³	NO
	LEVEL 2 - NORTH	B202	2B+2BA	F5-1	2 BED	88 m²		YES	YES	4m³	NO
	LEVEL 2 - NORTH	B203	2B+2BA	F1-1	2 BED	82 m²		YES	YES	4m³	NO
	LEVEL 2 - NORTH LEVEL 2 - NORTH	B204 B205	2B+2BA 1B	F2-1 B1-1	2 BED 1 BED	78 m ² 51 m ²	LIV	NO NO	YES YES	4m³ 3m³	NO NO
	LEVEL 2 - NORTH	B206	2B	B14	1 BED	70 m ²	ADAPT/LIV	YES	YES	3m³	NO
	LEVEL 2 - NORTH	B207	1B	B2-1	1 BED	54 m²		NO	NO	3m³	NO
	LEVEL 2 - NORTH	B208	2B+2BA	F3-1	2 BED	77 m²		NO	NO	4m³	NO
	LEVEL 2 - NORTH LEVEL 2 - NORTH	B209 B210	2B+2BA 2B	F17 F6-1	2 BED 2 BED	83 m ² 77 m ²		YES YES	NO YES	4m³ 4m³	NO NO
	LEVEL 2 - NORTH	B211	2B+2BA	F3-3	2 BED	80 m²		NO	YES	4m³	NO
						844 m²					
	LEVEL 3 - NORTH	B301	3B	J2-1	3 BED	105 m²	LIV	YES	YES	5m³	NO
	LEVEL 3 - NORTH	B302	2B+2BA	F5-1	2 BED	88 m²	LIV	YES	YES	4m³	NO
	LEVEL 3 - NORTH	B303	2B+2BA	F1-1	2 BED	82 m²		YES	YES	4m³	NO
	LEVEL 3 - NORTH	B304	2B+2BA	F2-1	2 BED	78 m²	1.07	NO	YES	4m³	NO
	LEVEL 3 - NORTH LEVEL 3 - NORTH	B305 B306	1B 2B	B1-1 B14	1 BED	51 m ² 70 m ²	ADAPT/LIV	NO YES	YES YES	3m³ 3m³	NO NO
	LEVEL 3 - NORTH	B307	1B	B2-1	1 BED	55 m ²	ADAF I/LIV	NO NO	NO	3m³	NO
	LEVEL 3 - NORTH	B308	2B+2BA	F3-1	2 BED	77 m²		NO	NO	4m³	NO
	LEVEL 3 - NORTH	B309	2B+2BA	F17	2 BED	83 m²		YES	NO	4m³	NO
	LEVEL 3 - NORTH LEVEL 3 - NORTH	B310 B311	2B 2B+2BA	F6-1 F3-3	2 BED 2 BED	78 m ² 80 m ²		YES NO	YES YES	4m³ 4m³	NO NO
1		120		1.00		845 m²				1	1,10
	LEVEL 4 NODTH	D404	20	10.4	2.000	1052	1.157	VEC	VEC	Ema3	NO
	LEVEL 4 - NORTH LEVEL 4 - NORTH	B401 B402	3B 2B+2BA	J2-1 F5-1	3 BED 2 BED	105 m ² 88 m ²	LIV	YES YES	YES YES	5m³ 4m³	NO NO
	LEVEL 4 - NORTH	B403	2B+2BA	F1-1	2 BED	82 m²		YES	YES	4m³	NO
	LEVEL 4 - NORTH	B404	2B+2BA	F2-1	2 BED	78 m²		YES	YES	4m³	NO
	LEVEL 4 - NORTH	B405	1B	B1-1	1 BED	51 m ²	LIV	YES	YES	3m³	NO
	LEVEL 4 - NORTH LEVEL 4 - NORTH	B406 B407	2B 1B	B14 B2-2	1 BED	70 m ² 54 m ²	ADAPT/LIV	YES YES	YES NO	4m³ 3m³	NO NO
	LEVEL 4 - NORTH	B408	2B+2BA	F3-1	2 BED	77 m ²		NO	NO	4m³	NO
	LEVEL 4 - NORTH	B409	2B+2BA	F17	2 BED	83 m²		YES	NO	4m³	NO
	LEVEL 4 - NORTH LEVEL 4 - NORTH	B410 B411	2B 2B+2BA	F6-1 F3-3	2 BED 2 BED	77 m ² 80 m ²		YES NO	YES YES	4m³ 4m³	NO NO
	LLVEL 4 - NORTH	D411	ZDŦZDA	г з- з	Z DED	844 m²		INO	IES	77111	INO
							_				
	LEVEL 5 - NORTH	B501	1B	B2-2	1 BED	56 m²		YES	YES	3m³	NO
	LEVEL 5 - NORTH LEVEL 5 - NORTH	B502 B503	2B+2BA 2B+2BA	F3-1 F17	2 BED 2 BED	77 m ² 83 m ²		NO YES	NO NO	4m³ 4m³	NO NO
	LEVEL 5 - NORTH	B504	3B	J8	3 BED	91 m ²		YES	YES	5m³	NO
	LEVEL 5 - NORTH	B505	1B	B16	1 BED	61 m²		NO	YES	3m³	NO
						368 m²					
	LEVEL 6 - NORTH	B601	1B	B2-2	1 BED	56 m²		YES	YES	3m³	NO
	LEVEL 6 - NORTH	B602	2B+2BA	F3-1	2 BED	77 m²		NO	NO	4m³	NO
	LEVEL 6 - NORTH	B603	2B+2BA	F17	2 BED	83 m²		YES YES	NO	4m³	NO
	LEVEL 6 - NORTH LEVEL 6 - NORTH	B604 B605	3B 1B	J8 B16	3 BED 1 BED	91 m ² 61 m ²		NO YES	YES YES	5m³ 3m³	NO NO
			- I	1 *		368 m²		ı	1	1	
	LEVEL 7 NORTH	D704	4D	D0 0	4.050	FC :2	T	VEC	VEC	23	NO
	LEVEL 7 - NORTH LEVEL 7 - NORTH	B701 B702	1B 2B+2BA	B2-2 F3-1	1 BED 2 BED	56 m ² 77 m ²		YES YES	YES YES	3m³ 4m³	NO NO
	LEVEL 7 - NORTH	B702	2B+2BA	F17	2 BED	83 m ²		YES	YES	4m³	NO
	LEVEL 7 - NORTH	B704	3B	J8	3 BED	92 m²		YES	YES	5m³	NO
	LEVEL 7 - NORTH	B705	1B	B16	1 BED	61 m ²		YES	YES	3m³	NO

BUILDING		UNIT	BEDS	TYPE	BEDS	ADEA	ADAPTABLE /	NATURAL CROSS	2 HOURS SOLAR	ADADTMENT	AFFORDABLE HOUSING
BUILDING	LEVEL	NO.	BED2	ITPE	BED9	AREA	LIVABLE	VENTILATION	ACCESS	STORAGE	AFFORDABLE HOUSING
	LEVEL 1 (G) - SOUTH	C101	1B	B8-2	1 BED	50 m²	LIV	YES	YES	3m³	NO
	LEVEL 1 (G) - SOUTH LEVEL 1 (G) - SOUTH	C102 C103	1B 2B+2BA	B15 F1-3	1 BED 2 BED	59 m² 77 m²	LIV ADAPT/LIV	YES NO	YES YES	4m³ 4m³	NO NO
	LEVEL 1 (G) - SOUTH	C104	1B	B10	1 BED	59 m²	ADAI I/LIV	NO	YES	3m³	NO
	LEVEL 1 (G) - SOUTH	C105 C106	1B 2B+2BA	B13 F14	1 BED 2 BED	86 m ² 88 m ²		NO YES	YES NO	3m³ 4m³	NO NO
	LEVEL 1 (G) - SOUTH	C107	2B+2BA	F8	2 BED	75 m²		YES	NO	4m³	NO
	LEVEL 1 (G) - SOUTH	C108 C109	1B 2B+2BA	B12 F15-2	1 BED 2 BED	52 m ² 79 m ²		NO YES	YES YES	3m³ 4m³	NO NO
)	LEVEL 1 (G) - SOUTH	C110	2B+2BA	F16-2	2 BED	85 m ² 710 m ²		YES	YES	4m³	NO
	LEVEL 2 - SOUTH	C201	1B	B8-1	1 BED	54 m²	LIV	YES	YES	3m³	NO
	LEVEL 2 - SOUTH	C201	2B+2BA	F9-1	2 BED	75 m ²	LIV	YES	YES	4m³	NO
	LEVEL 2 - SOUTH	C203 C204	2B+2BA 2B+2BA	F2-4 F1-2	2 BED 2 BED	76 m ² 75 m ²	ADAPT/LIV	NO NO	YES YES	4m³ 4m³	NO NO
;	LEVEL 2 - SOUTH	C205	2B+2BA	F7	2 BED	90 m²		YES	YES	4m³	NO
	LEVEL 2 - SOUTH	C206 C207	2B+2BA 2B+2BA	F7 F1-2	2 BED 2 BED	90 m ² 76 m ²		YES NO	YES YES	4m³ 4m³	NO NO
	LEVEL 2 - SOUTH	C208	2B+2BA	F2-4	2 BED	76 m²	ADAPT/LIV	NO	YES	4m³	NO
:	LEVEL 2 - SOUTH	C209 C210	2B+2BA 2B+2BA	F15-1 F16-1	2 BED 2 BED	78 m ² 83 m ²		YES YES	YES NO	4m³ 4m³	NO NO
,	LEVEL 2 - SOUTH	C211	2B+2BA	F8R	2 BED	77 m²		YES	NO	4m³	NO
<u>;</u>	LEVEL 2 - SOUTH	C212 C213	1B 1B	B4R B4	1 BED	53 m ²		NO NO	NO NO	3m³ 3m³	NO NO
4	LEVEL 2 - SOUTH	C214	2B+2BA	F8	2 BED	75 m ² 1028 m ²		YES	NO	4m³	NO
•											,
	LEVEL 3 - SOUTH	C301 C302	1B 2B+2BA	B8-1 F9-1	1 BED 2 BED	54 m ² 76 m ²	LIV	YES YES	YES YES	3m³ 4m³	NO NO
,	LEVEL 3 - SOUTH	C303	2B+2BA	F2-4	2 BED	76 m²	ADAPT/LIV	NO	YES	4m³	NO
;	LEVEL 3 - SOUTH	C304 C305	2B+2BA 2B+2BA	F1-2 F7	2 BED 2 BED	75 m ² 90 m ²		NO YES	YES YES	4m³ 4m³	NO NO
;	LEVEL 3 - SOUTH	C306	2B+2BA	F7	2 BED	90 m²		YES	YES	4m³	NO
;	LEVEL 3 - SOUTH	C307 C308	2B+2BA 2B+2BA	F1-2 F2-4	2 BED 2 BED	76 m ²	ADAPT/LIV	NO NO	YES YES	4m³ 4m³	NO NO
<u> </u>	LEVEL 3 - SOUTH	C309	2B+2BA	F15-1	2 BED	78 m²		YES	YES	4m³	NO
<u>;</u>	LEVEL 3 - SOUTH	C310 C311	2B+2BA 2B	F16-1 F8R	2 BED 2 BED	83 m ² 76 m ²		YES YES	NO NO	5m³ 4m³	NO NO
	LEVEL 3 - SOUTH	C312	1B	B4R	1 BED	54 m²		NO	NO	3m³	NO
	LEVEL 3 - SOUTH	C313	1B 2B+2BA	B4 F8	1 BED 2 BED	51 m ² 75 m ²		NO YES	NO NO	3m³ 4m³	NO NO
4		_		-		1028 m²					
:	LEVEL 4 - SOUTH	C401	1B	B8-1	1 BED	54 m²	LIV	YES	YES	3m³	NO
	LEVEL 4 - SOUTH	C402	2B+2BA 2B+2BA	F9-1 F2-4	2 BED 2 BED	76 m² 76 m²	LIV ADAPT/LIV	YES	YES YES	4m³ 4m³	NO NO
<u>, </u>	LEVEL 4 - SOUTH	C403 C404	2B+2BA 2B+2BA	F1-2	2 BED	76 m²	ADAPT/LIV	NO NO	YES	4m³	NO
,	LEVEL 4 - SOUTH	C405 C406	1B 1B	F7 F7R	1 BED 1 BED	51 m ²		NO NO	YES YES	3m³ 3m³	NO NO
, ,	LEVEL 4 - SOUTH	C400	2B+2BA	F1-2	2 BED	76 m ²		NO	YES	4m³	NO
	LEVEL 4 - SOUTH	C408 C409	2B+2BA 2B+2BA	F2-4 F15-1	2 BED 2 BED	76 m ² 78 m ²	ADAPT/LIV	NO YES	YES YES	4m³ 4m³	NO NO
,	LEVEL 4 - SOUTH	C410	2B+2BA	F16-1	2 BED	83 m ²		YES	NO	4m³	NO
	LEVEL 4 - SOUTH	C411 C412	2B+2BA 2B+2BA	F8R B4R	2 BED 2 BED	76 m ² 75 m ²		YES NO	NO NO	4m³ 4m³	NO NO
	LEVEL 4 - SOUTH	C413	2B+2BA	B4	2 BED	75 m²		NO	NO	4m³	NO
4	LEVEL 4 - SOUTH	C414	2B+2BA	F8	2 BED	75 m ² 997 m ²		YES	NO	4m³	NO
2	LEVEL 5 - SOUTH	C501	1B	B8-1	1 BED	54 m²	LIV	YES	YES	3m³	NO
·	LEVEL 5 - SOUTH	C502	2B+2BA	F9-1	2 BED	76 m²	LIV	YES	YES	4m³	NO
;	LEVEL 5 - SOUTH	C503 C504	2B+2BA 2B+2BA	F2-4 F1-2	2 BED 2 BED	76 m ²	ADAPT/LIV	NO NO	YES YES	4m³ 4m³	NO NO
;	LEVEL 5 - SOUTH	C505	2B+2BA	F7	2 BED	90 m²		YES	YES	4m³	NO
	LEVEL 5 - SOUTH	C506 C507	2B+2BA 2B+2BA	F7 F1-2	2 BED 2 BED	90 m ² 75 m ²		YES NO	YES YES	4m³ 4m³	NO NO
,	LEVEL 5 - SOUTH	C508	2B+2BA	F2-4	2 BED	76 m²	ADAPT/LIV	NO	YES	4m³	NO
; ;	LEVEL 5 - SOUTH	C509 C510	2B+2BA 2B+2BA	F15-1 F16-1	2 BED 2 BED	78 m² 83 m²		YES YES	YES NO	4m³ 4m³	NO NO
	LEVEL 5 - SOUTH	C511	2B+2BA	F8R	2 BED	76 m²		YES	NO	4m³	NO
	LEVEL 5 - SOUTH LEVEL 5 - SOUTH	C512 C513	1B 1B	B4R B4	1 BED 1 BED	53 m ² 51 m ²		NO NO	NO NO	3m³ 3m³	NO NO
4	LEVEL 5 - SOUTH	C514	2B+2BA	F8	2 BED	75 m ² 1027 m ²		YES	NO	4m³	NO
	LEVEL 6 SOUTH	C601	2P+2P4	EQ 4	2 BED		LIV	VES	VES	4m³	NO
	LEVEL 6 - SOUTH LEVEL 6 - SOUTH	C601 C602	2B+2BA 2B+2BA	F9-1 F2-4	2 BED 2 BED	76 m ²	LIV ADAPT/LIV	YES NO	YES YES	4m³ 4m³	NO NO
	LEVEL 6 - SOUTH	C603	2B+2BA	F1-2	2 BED	75 m²		NO	YES	4m³	NO
	LEVEL 6 - SOUTH LEVEL 6 - SOUTH	C604 C605	2B+2BA 2B+2BA	F7 F7	2 BED 2 BED	90 m ²		YES YES	YES YES	4m³ 4m³	NO NO
<u> </u>	LEVEL 6 - SOUTH	C606 C607	3B 2B+2BA	F1-2 F2-4	2 BED 2 BED	75 m ² 76 m ²	LIV	NO NO	YES YES	4m³ 4m³	NO NO
	LEVEL 6 - SOUTH	C608	2B	F15-1	2 BED	78 m²	LIV	YES	YES	4m³	NO
	LEVEL 6 - SOUTH LEVEL 6 - SOUTH	C609 C610	2B+2BA 2B+2BA	F16-1 F8	2 BED 2 BED	83 m² 76 m²		YES YES	NO NO	4m³ 4m³	NO NO
	LEVEL 6 - SOUTH	C611	1B	B4-1	1 BED	53 m²		NO	NO	3m³	NO
	LEVEL 6 - SOUTH LEVEL 6 - SOUTH	C612 C613	1B 2B+2BA	B4 F8	1 BED 2 BED	51 m ² 75 m ²		NO YES	NO NO	3m³ 4m³	NO NO
3	,	1-2-3				973 m²	<u>'</u>	-	'	_	
	LEVEL 7 - SOUTH	C701	3B	J5	3 BED	100 m²		YES	YES	5m³	NO
	LEVEL 7 - SOUTH	C702 C703	2B+2BA 2B	F2-4 F15-1	2 BED 2 BED	76 m² 78 m²	LIV	NO YES	YES YES	4m³ 4m³	NO NO
	LEVEL 7 - SOUTH	C704	2B	J4	2 BED	83 m²		YES	NO	4m³	NO
	LEVEL 7 - SOUTH	C705 C706	2B+2BA 2B+2BA	F8 B4R	2 BED 1 BED	76 m² 50 m²		YES YES	NO NO	4m³ 3m³	NO NO
;	-L-VLL	10100	ZD ZDA	ריירי	1 DED	463 m²	1	1,10	Ino	on	ļito.
	LEVEL 8 - SOUTH	C801	3B	J7	3 BED	106 m²		YES	YES	5m³	NO
	LEVEL 8 - SOUTH	C802	2B+2BA	F2-4	2 BED	76 m²	LIV	YES	YES	4m³	NO
	LEVEL 8 - SOUTH	C803	2B 2B+2BA	F15-3 F16-1	2 BED 2 BED	80 m ²		YES YES	YES YES	4m³ 4m³	NO NO
; ;	LEVEL 8 - SOUTH	C804	3B		3 BED			YES	YES	5m³	NO

UNIT TYPES - BUILDING A						
1 BED						
11 (40.7%						
2 BED						
13 (48.1%						
3 BED						
3 (11.2%)						
TOTAL: 27						

UNIT T	YPES -	BUILDI	NG B	
1 BED				
19 (32.3%)				
2 BED				
34 (54.8%)				
3 BED				
8 (12.9%)				
TOTAL: 61				

UNIT TYPES - BUILDING C	
1 BED	
20(22.2%)	
2 BED	
67 (75.6%)	
B BED	
3 (2.2%)	
TOTAL: 90	

UNIT TYPES - T	OTAL
1 BED	
50(28.5%)	
2 BED	
114 (64.2%)	
3 BED	
14(7.3%)	
TOTAL: 178	

	BEDS	AFFORDABLE HOUSING
1404	4D - OT	\/F0
		YES
A201	1B+ST	YES
A202	2B+2BA	YES
A203	2B+2BA	YES
A204	1B	YES
A205	2B+2BA	YES
A206	3B	YES
A207	1B	YES
A301	1B+ST	YES
A302	2B+2BA	YES
A303	2B+2BA	YES
A304	1B	YES
A305	2B+2BA	YES
A306	3B	YES
A307	1B	YES
A401	1B+ST	YES
A402	2B+2BA	YES
A403	2B+2BA	YES
A404	1B	YES
A405	2B+2BA	YES
A406	3B	YES
A407		YES
	A203 A204 A205 A206 A207 A301 A302 A303 A304 A305 A306 A307 A401 A402 A403 A404 A405 A406	A102 2B+2BA A103 2B+2BA A104 2B+2BA A105 2B A106 1B+ST A201 1B+ST A202 2B+2BA A203 2B+2BA A204 1B A205 2B+2BA A206 3B A207 1B A301 1B+ST A302 2B+2BA A303 2B+2BA A301 1B+ST A302 2B+2BA A301 1B+ST A302 2B+2BA A303 2B+2BA A304 1B A307 1B A307 1B A307 1B A307 1B A401 1B+ST A402 2B+2BA A403 2B+2BA A403 2B+2BA A403 2B+2BA A404 1B A405 2B+2BA A406 3B

issue amendment	date	legend	architect		project	RESIDENTIA	L APARTMENT DEVELOPMENT
A ISSUE FOR DEVELOPMENT APPLICATION B AMENDMENTS INCORPORATING DEP COMMEN' P1 ISSUE PRELIMINARY SKETCH DESIGN P2 ISSUE FOR FINAL SKETCH DESIGN	03.11.21 TS 26.05.22 11.01.24 18.01.24		stanisic architects Level 10 257 Claret T (61 2) 9358 2588 www.stanisic.com.a NSW ARB Frank St				T 101 DP 1267563 SOMME AVENUE EDMONDSON PARK
C ISSUE FOR AMENDING DEVELOPMENT APPLICA			client		checked	drawing JN	ACCOMMODATION SCHEDULE
24 4:42:4			CROATIA 88 PTY LTD	scale	drawn	issue SV	C
do not scale from drawings.		the layout shown and the areas noted on this drawing are indicative only. layouts are to be read in conjunction with floor plans, elevations + sections.		scale bar	project no	drawing no	DA 0002

LEVEL	TYPE	NO.
BASEMENT 2 - NORTH	RESIDENTIAL (TANDEM) - 2400 x 5500	4
BASEMENT 2 - NORTH	RESIDENTIAL - 2500 x 5500	68
72	,	
LEVEL LG (B1) - NORTH	LOADING BAY/VISITOR	1
LEVEL LG (B1) - NORTH LEVEL LG (B1) - NORTH	LOADING BAY/VISITOR RESIDENTIAL (TANDEM) - 2400 x 5500	1 5
LEVEL LG (B1) - NORTH		1 5 14
LEVEL LG (B1) - NORTH LEVEL LG (B1) - NORTH	RESIDENTIAL (TANDEM) - 2400 x 5500	
LEVEL LG (B1) - NORTH LEVEL LG (B1) - NORTH LEVEL LG (B1) - NORTH	RESIDENTIAL (TANDEM) - 2400 x 5500 RESIDENTIAL - 2500 x 5500	14

LEVEL	TYPE	NO.						
BASEMENT 4 - SOUTH	RESIDENTIAL 5400 x 2500 PARALLEL	3						
BASEMENT 4 - SOUTH	RESIDENTIAL - 2500 x 5500	32						
35								
BASEMENT 3 - SOUTH	RESIDENTIAL 5400 x 2500 PARALLEL	3						
BASEMENT 3 - SOUTH	RESIDENTIAL - 2500 x 5500	27						
BASEMENT 3 - SOUTH	RESIDENTIAL ACCESSIBLE - 2500 x 5500	1						
31 BASEMENT 2 - SOUTH	RESIDENTIAL 5400 x 2500 PARALLEL	3						
BASEMENT 2 - SOUTH	RESIDENTIAL 3400 X 2500 FARALLEL RESIDENTIAL (TANDEM) - 2400 X 5500	3						
BASEMENT 2 - SOUTH	RESIDENTIAL (TANDEM) - 2400 x 3300	12						
BASEMENT 2 - SOUTH	RESIDENTIAL - 2500 x 5500	9						
BASEMENT 2 - SOUTH	RESIDENTIAL VISITOR - 2500 x 5500	3						
30								
		1.						
BASEMENT 1 - SOUTH	LOADING BAY/VISITOR	1						
BASEMENT 1 - SOUTH BASEMENT 1 - SOUTH	LOADING BAY/VISITOR RESIDENTIAL VISITOR - 2500 x 5500	1 17						

PARKING SCHEDULE BUILDING A+B (BY TYPE)		
TYPE	NO.	
LOADING BAY/VISITOR	1	
RESIDENTIAL (TANDEM) - 2400 x 5500	9	
RESIDENTIAL - 2500 x 5500	82	
RESIDENTIAL ACCESSIBLE - 2500 x 5500	8	
RESIDENTIAL VISITOR - 2500 x 5500	20	
RESIDENTIAL VISITOR ACCESSIBLE - 2500 x 5500	1	

TYPE	NO.
LOADING BAY/VISITOR	1
RESIDENTIAL 5400 x 2500 PARALLEL	9
RESIDENTIAL (TANDEM) - 2400 x 5500	3
RESIDENTIAL - 2500 x 5500	71
RESIDENTIAL ACCESSIBLE - 2500 x 5500	10
RESIDENTIAL VISITOR - 2500 x 5500	20
RESIDENTIAL VISITOR ACCESSIBLE - 2500 x 5500	2
116	

legend

03.11.21

26.05.22

11.01.24

18.01.24

CAR PARKING RATES: 1 BED 2 BED 3 BED RESIDENTIAL VISITOR ADAPTABLE	1 1 2 1/4 (DCP) 10% (DCP)
BUILDING A + B CAR PARKING: 1 BED x 30 2 BED x 47 3 BED x 11 RESIDENTIAL VISITOR TOTAL ADAPTABLE	30 47 22 22 22 121 8.9(9)
BUILDING C CAR PARKING: 1 BED x 20 2 BED x 67 3 BED x 3 RESIDENTIAL VISITOR TOTAL ADAPTABLE	20 67 6 22.5 (23) 116 9

ISSUE FOR DEVELOPMENT APPLICATION

ISSUE PRELIMINARY SKETCH DESIGN

ISSUE FOR FINAL SKETCH DESIGN

AMENDMENTS INCORPORATING DEP COMMENTS

ISSUE FOR AMENDING DEVELOPMENT APPLICATION

issue amendment

do not scale from drawings.

116

LIVERPOOL LEP 2008

gross floor area means the sum of the floor area of each floor of a building measured from the internal face of external walls, or from the internal face of walls separating the building from any other building, measured at a height of 1.4 metres above the floor, and includes:

SEPP (HOUSING) 2023 - CL 12a -LIMITATION ON ADDITIONAL FLOOR

The maximum floor space ratio for the

development is 130% of the maximum

SEPP (HOUSING) 2023 - CL 17(1) -

The maximum floor space ratio for

development to which this division applies is

ratio for residential accommodation on the

SEPP (HOUSING) 2023 - CL 16(1)(b) -

Development to which division applies

130% of the maximum permissible floor space

permissible floor space ratio.

Additional floor space

SPACE RATIO

land.

- (a) the area of a mezzanine, and habitable rooms in a basement or an attic, and
- (c) any shop, auditorium, cinema, and the like, in a basement or attic:

but excludes:

- (d) any area for common vertical circulation, such as lifts and stairs, and
- (e) any basement:
 - (i) storage, and (ii) vehicular access, loading areas, garbage and
- services, and plant rooms, lift towers and other areas used exclusively
- for mechanical services or ducting, and car parking to meet any requirements of the consent
- authority (including access to that car parking), and any space used for the loading or unloading of goods (including access to it), and
- terraces and balconies with outer walls less than 1.4 metres high, and
- voids above a floor at the level of a storey or storey

AFFORDABLE HOUSING AREA SCHEDULE		
BUILDING	LEVEL	AREA (m²)
Α	LEVEL 1 (G) - NORTH	570 m²
A	LEVEL 2 - NORTH	603 m ²
Α	LEVEL 3 - NORTH	603 m²

MINIMUM AFFORDABLE HOUSING (15% TOTAL GFA) 2380 m²

LEVEL 4 - NORTH

FOR AFFORDABLE HOUSING AREA DIAGRAMS - REFER TO DRAWING 8018.

	RESIDENTIAL (TANDEM) - 2400 x 5500	9
\geq	RESIDENTIAL - 2500 x 5500	82
	RESIDENTIAL ACCESSIBLE - 2500 x 5500	8
	99	
	LOADING BAY/VISITOR	1
	RESIDENTIAL VISITOR - 2500 x 5500	20
	RESIDENTIAL VISITOR ACCESSIBLE - 2500 x 5500	1
	22	

603 m²

2380 m²

	RESIDENTIAL 5400 x 2500 PARALLEL	9
_	RESIDENTIAL (TANDEM) - 2400 x 5500	3
7	RESIDENTIAL - 2500 x 5500	71
	RESIDENTIAL ACCESSIBLE - 2500 x 5500	10
	93	
	LOADING BAY/VISITOR	1
	RESIDENTIAL VISITOR - 2500 x 5500	20
	RESIDENTIAL VISITOR ACCESSIBLE - 2500 x 5500	2

SOLAR ACCESS (9AM-3PM)
YES
124/178 (69.7%)
ADG GUIDELINE = 125.3 (70%)
APPROVED APARTMENTS RECEIVING >2 HRS SOLAR ACCESS AT MID WINTER ADDITIONAL APARTMENTS RECEIVING >2 HRS SOLAR ACCESS AT MID-WINTER
NATURAL CROSS VENTILATION
YES
111/178 (62.4%)

APPROVED APARTMENTS ACHIEVING NATURAL CROSS VENTILATION 82

ADDITIONAL APARTMENTS ACHIEVING NATURAL CROSS VENTILATION 29

ADG GUIDELINE = 107.4 (60%)

GFA SCHEDULE			
LEVEL	GFA (m²)	FSR (x:1	
BUILDING A:		-	
LEVEL 1 (G) - NORTH	570.01	0.06	
LEVEL 2 - NORTH	603.23	0.06	
LEVEL 3 - NORTH	603.26	0.06	
LEVEL 4 - NORTH	603.24	0.06	
	2379.74	0.24	
BUILDING B (0.75:1 PORTION):			
LEVEL LG (B1) - NORTH	93.17	0.01	
LEVEL 1 (G) - NORTH	669.72	0.07	
LEVEL 2 - NORTH	718.11	0.07	
LEVEL 3 - NORTH	727.58	0.07	
LEVEL 4 - NORTH	722.57	0.07	
LEVEL 5 - NORTH	156.06	0.02	
LEVEL 6 - NORTH	156.05	0.02	
LEVEL 7 - NORTH	156.05	0.02	
	3399.31	0.34	
BUILDING B (1.5:1 PORTION):			
LEVEL LG (B1) - NORTH	215.01	0.02	
LEVEL 1 (G) - NORTH	275.28	0.03	
LEVEL 2 NODTH	274 00	0.03	

	LEVEL LG (B1) - NOKIII	213.01	0.02
At least 15% of the gross floor area of the part	LEVEL 1 (G) - NORTH	275.28	0.03
of the building resulting from the development	LEVEL 2 - NORTH	274.88	0.03
that is used for residential development will be	LEVEL 3 - NORTH	274.88	0.03
used for the purposes of affordable housing.	LEVEL 4 - NORTH	274.49	0.03
	LEVEL 5 - NORTH	274.64	0.03
	LEVEL 6 - NORTH	274.64	0.03
	LEVEL 7 - NORTH	274.64	0.03
		2138.46	0.21
	BUILDING C:		
	LEVEL 1 (G) - SOUTH	913.53	0.09
	LEVEL 2 - SOUTH	1198.52	0.12
	LEVEL 3 - SOUTH	1202.33	0.12
	LEVEL 4 - SOUTH	1192.39	0.12
	LEVEL 5 - SOUTH	1200.53	0.12
	LEVEL 6 - SOUTH	1137.56	0.11
	LEVEL 7 - SOUTH	567.36	0.06
	LEVEL 8 - SOUTH	537.77	0.05
		7949.99	0.79
	PROPOSED TOTAL	15867.49	1.57
	PROPOSED (0.75:1 PORTION)	5779.05	1.46
	PROPOSED (0.75.1 PORTION) PROPOSED (1.5:1 PORTION)	10088.45	1.64

TOTAL DEVELOPMENT SITE AREA:

MAXIMUM PERMISSIBLE (LEP)

SITE AREA - NORTH (0.75:1)

(EXCLUDES ROAD WIDENING + RE1 LAND)

SITE AREA - SOUTH (1.5:1)

NAME LANDS	SCAPED AREA	(m²)
LANDSCAPED OPEN SPACE SCHEDULE	.	
MAXIMUM PERMISSIBLE (130% MAXIMUM PERMISSIBLE GFA)	15867.64 1	.57

10111.5

12205.88

1.21

3948.5

6163

LANDSCAPED AREA 1	2782 m²
LANDSCAPED AREA 2	1077 m²
LANDSCAPED AREA 3	680 m²
TOTAL	4523 m² (44.7%)
SITE AREA	10111.5 m²

MINIMUM REQUIRED LANDSCAPED AREA 3033.45 m² (30% SITE AREA) SEPP (HOUSING) 2023 - CL 19(2)(b)

NOTE: PUBLIC RESERVATION DEDICATIONS HAVE BEEN EXCLUDED

DEEP SOIL SCHEDULE	
NAME	LANDSCAPED AREA (m²)

DEEP SOIL AREA 1	1753 m²
DEEP SOIL AREAS 2-4	530 m²
TOTAL	2283 m² (22.6%)
SITE AREA	10111.5 m²
MINIMUM RECOMMENDED DEEP SOIL ZONE OBJECTIVE 3E-1	707.8 m² (7% SITE AREA)

NOTE: PUBLIC RESERVATION DEDICATIONS HAVE BEEN EXCLUDED

COMMUNAL OPEN SPACE SCHEDULE		
NAME LANDSCAPED AREA (n		
COMMUNAL OPEN AREA 1	2782 m²	
COMMUNAL OPEN AREA 2	1077 m²	
COMMUNAL OPEN AREA 3	680 m²	
TOTAL	4523 m² (44.7%)	
SITE AREA	10111.5 m²	

NOTE: PUBLIC RESERVATION DEDICATIONS HAVE BEEN EXCLUDED

MINIMUM RECOMMENDED COMMUNAL OPEN SPACE 2527.88m² (25% SITE AREA)

scale

UNIT NO.	TYPE	LEVEL	ADAPTABLE / LIVABLE
A204	B1	LEVEL 2 - NORTH	LIV
A304	B1	LEVEL 3 - NORTH	LIV
A404	B1	LEVEL 4 - NORTH	LIV
B305	B1-1	LEVEL 3 - NORTH	LIV
B105	B1-1	LEVEL 1 (G) - NORTH	LIV
B205	B1-1	LEVEL 2 - NORTH	LIV
B405	B1-1	LEVEL 4 - NORTH	LIV
D403	D1-1	LEVEL 4 - NORTH	LIV
C201	B8-1	LEVEL 2 - SOUTH	LIV
C301	B8-1	LEVEL 3 - SOUTH	LIV
C401	B8-1	LEVEL 4 - SOUTH	LIV
C501	B8-1	LEVEL 5 - SOUTH	LIV
C101	B8-2	LEVEL 1 (G) - SOUTH	LIV
B306	B14	LEVEL 3 - NORTH	ADAPT/LIV
B106	B14	LEVEL 1 (G) - NORTH	ADAPT/LIV
B206	B14	LEVEL 2 - NORTH	ADAPT/LIV
B406	B14	LEVEL 4 - NORTH	ADAPT/LIV
C102	B15	LEVEL 1 (G) - SOUTH	LIV
C103	F1-3	LEVEL 1 (G) - SOUTH	ADAPT/LIV
0103	1-1-0	LLVLL 1 (G) - 300111	ADAF I/LIV
A203	F2-2	LEVEL 2 - NORTH	ADAPT/LIV
A303	F2-2	LEVEL 3 - NORTH	ADAPT/LIV
A403	F2-2	LEVEL 4 - NORTH	ADAPT/LIV
A103	F2-3	LEVEL 1 (G) - NORTH	ADAPT/LIV
C208	F2-4	LEVEL 2 - SOUTH	ADAPT/LIV
C203	F2-4	LEVEL 2 - SOUTH	ADAPT/LIV
C308	F2-4	LEVEL 3 - SOUTH	ADAPT/LIV
C303	F2-4	LEVEL 3 - SOUTH	
C408	F2-4		ADAPT/LIV
C408	F2-4	LEVEL 4 - SOUTH	ADAPT/LIV
	_	LEVEL 4 - SOUTH	ADAPT/LIV
C508	F2-4	LEVEL 5 - SOUTH	ADAPT/LIV
C503	F2-4	LEVEL 5 - SOUTH	ADAPT/LIV
C607	F2-4	LEVEL 6 - SOUTH	LIV
C602	F2-4	LEVEL 6 - SOUTH	ADAPT/LIV
C702	F2-4	LEVEL 7 - SOUTH	LIV
C802	F2-4	LEVEL 8 - SOUTH	LIV
C202	F9-1	LEVEL 2 - SOUTH	LIV
C302	F9-1	LEVEL 3 - SOUTH	LIV
C402	F9-1	LEVEL 4 - SOUTH	LIV
C502	F9-1	LEVEL 5 - SOUTH	LIV
C601	F9-1	LEVEL 6 - SOUTH	LIV
B301	J2-1	LEVEL 3 - NORTH	LIV
B201	J2-1	LEVEL 2 - NORTH	LIV
B401	J2-1	LEVEL 4 - NORTH	LIV

MINIMUM RECOMMENDED (ADG) 35.8 (20%)

LIVABLE APARTMENTS APPROVED LIVABLE APARTMENTS ADDITIONAL PROPOSED

FOR LIVABLE APARTMENT DETAILS - REFER TO DRAWING 8014-8015.

UNIT NO.	LEVEL	TYPE	ADAPTABLE /
B106	LEVEL 1 (G) - NORTH	B14	ADAPT/LIV
B206	LEVEL 2 - NORTH	B14	ADAPT/LIV
B306	LEVEL 3 - NORTH	B14	ADAPT/LIV
B406	LEVEL 3 - NORTH	B14	ADAPT/LIV
D400	LEVEL 4 - NORTH	D14	ADAF I/LIV
C103	LEVEL 1 (G) - SOUTH	F1-3	ADAPT/LIV
		·	
A203	LEVEL 2 - NORTH	F2-2	ADAPT/LIV
A303	LEVEL 3 - NORTH	F2-2	ADAPT/LIV
A403	LEVEL 4 - NORTH	F2-2	ADAPT/LIV
A103	LEVEL 1 (G) - NORTH	F2-3	ADAPT/LIV
	(-)		*
C208	LEVEL 2 - SOUTH	F2-4	ADAPT/LIV
C203	LEVEL 2 - SOUTH	F2-4	ADAPT/LIV
C308	LEVEL 3 - SOUTH	F2-4	ADAPT/LIV
C303	LEVEL 3 - SOUTH	F2-4	ADAPT/LIV
C408	LEVEL 4 - SOUTH	F2-4	ADAPT/LIV
C403	LEVEL 4 - SOUTH	F2-4	ADAPT/LIV
C508	LEVEL 5 - SOUTH	F2-4	ADAPT/LIV
C503	LEVEL 5 - SOUTH	F2-4	ADAPT/LIV
C602	LEVEL 6 - SOUTH	F2-4	ADAPT/LIV

ADAPTABLE APARTMENTS 18/178 (10.1%)
MINIMUM REQUIRED ADAPTABLE APARTMENTS (DCP) 17.9 (10%)

FOR ADAPTABLE APARTMENT DETAILS - REFER TO DRAWING 8014-8015.

BASEMENT STORAGE SCHEDULE			
BUILDING LEVEL		NO.	
A + B	BASEMENT 2 - NORTH	69	
A + B	LEVEL LG (B1) - NORTH	19	
		88	
С	BASEMENT 4 - SOUTH	35	
С	BASEMENT 3 - SOUTH	31	

BASEMENT 2 - SOUTH

TOTAL: 178

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CROATIA 88 PTY LTD

RESIDENTIAL APARTMENT DEVELOPMENT LOT 101 DP 1267563 SOMME AVENUE **EDMONDSON PARK**

drawing DEVELOPMENT DATA issue

the layout shown and the areas noted on this drawing are indicative only. layouts are to be read in conjunction with floor plans, elevations + sections.


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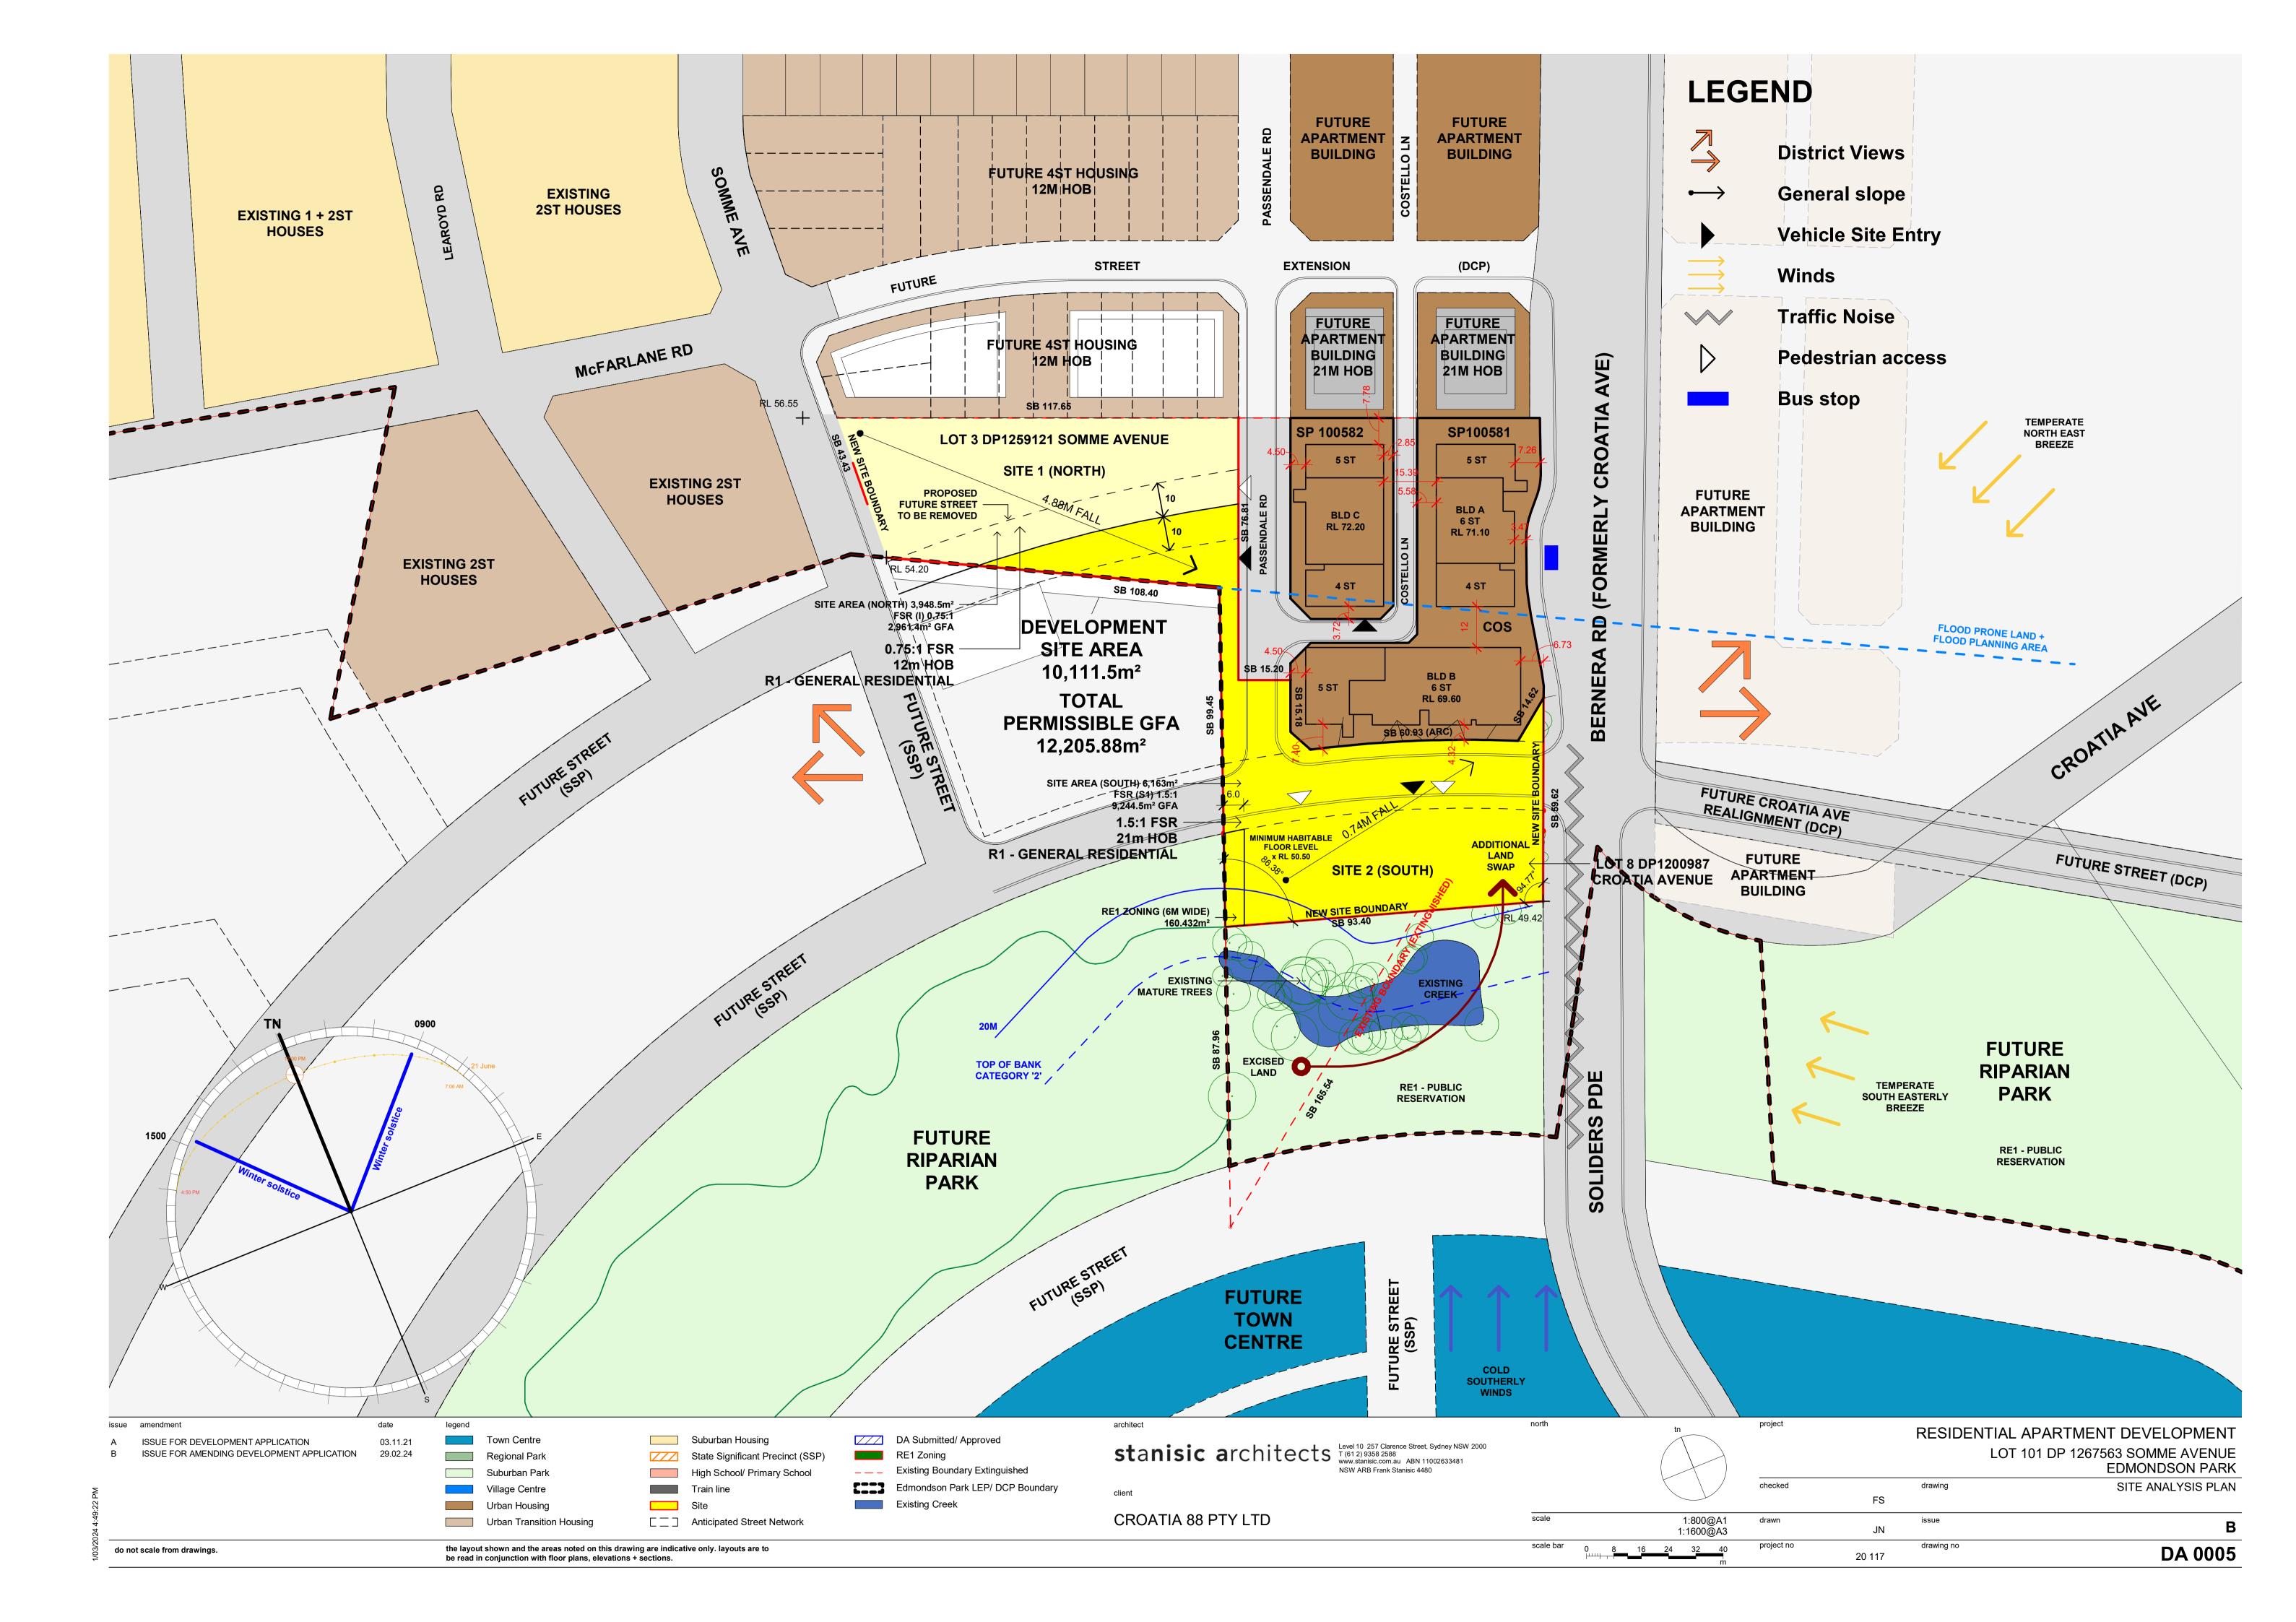
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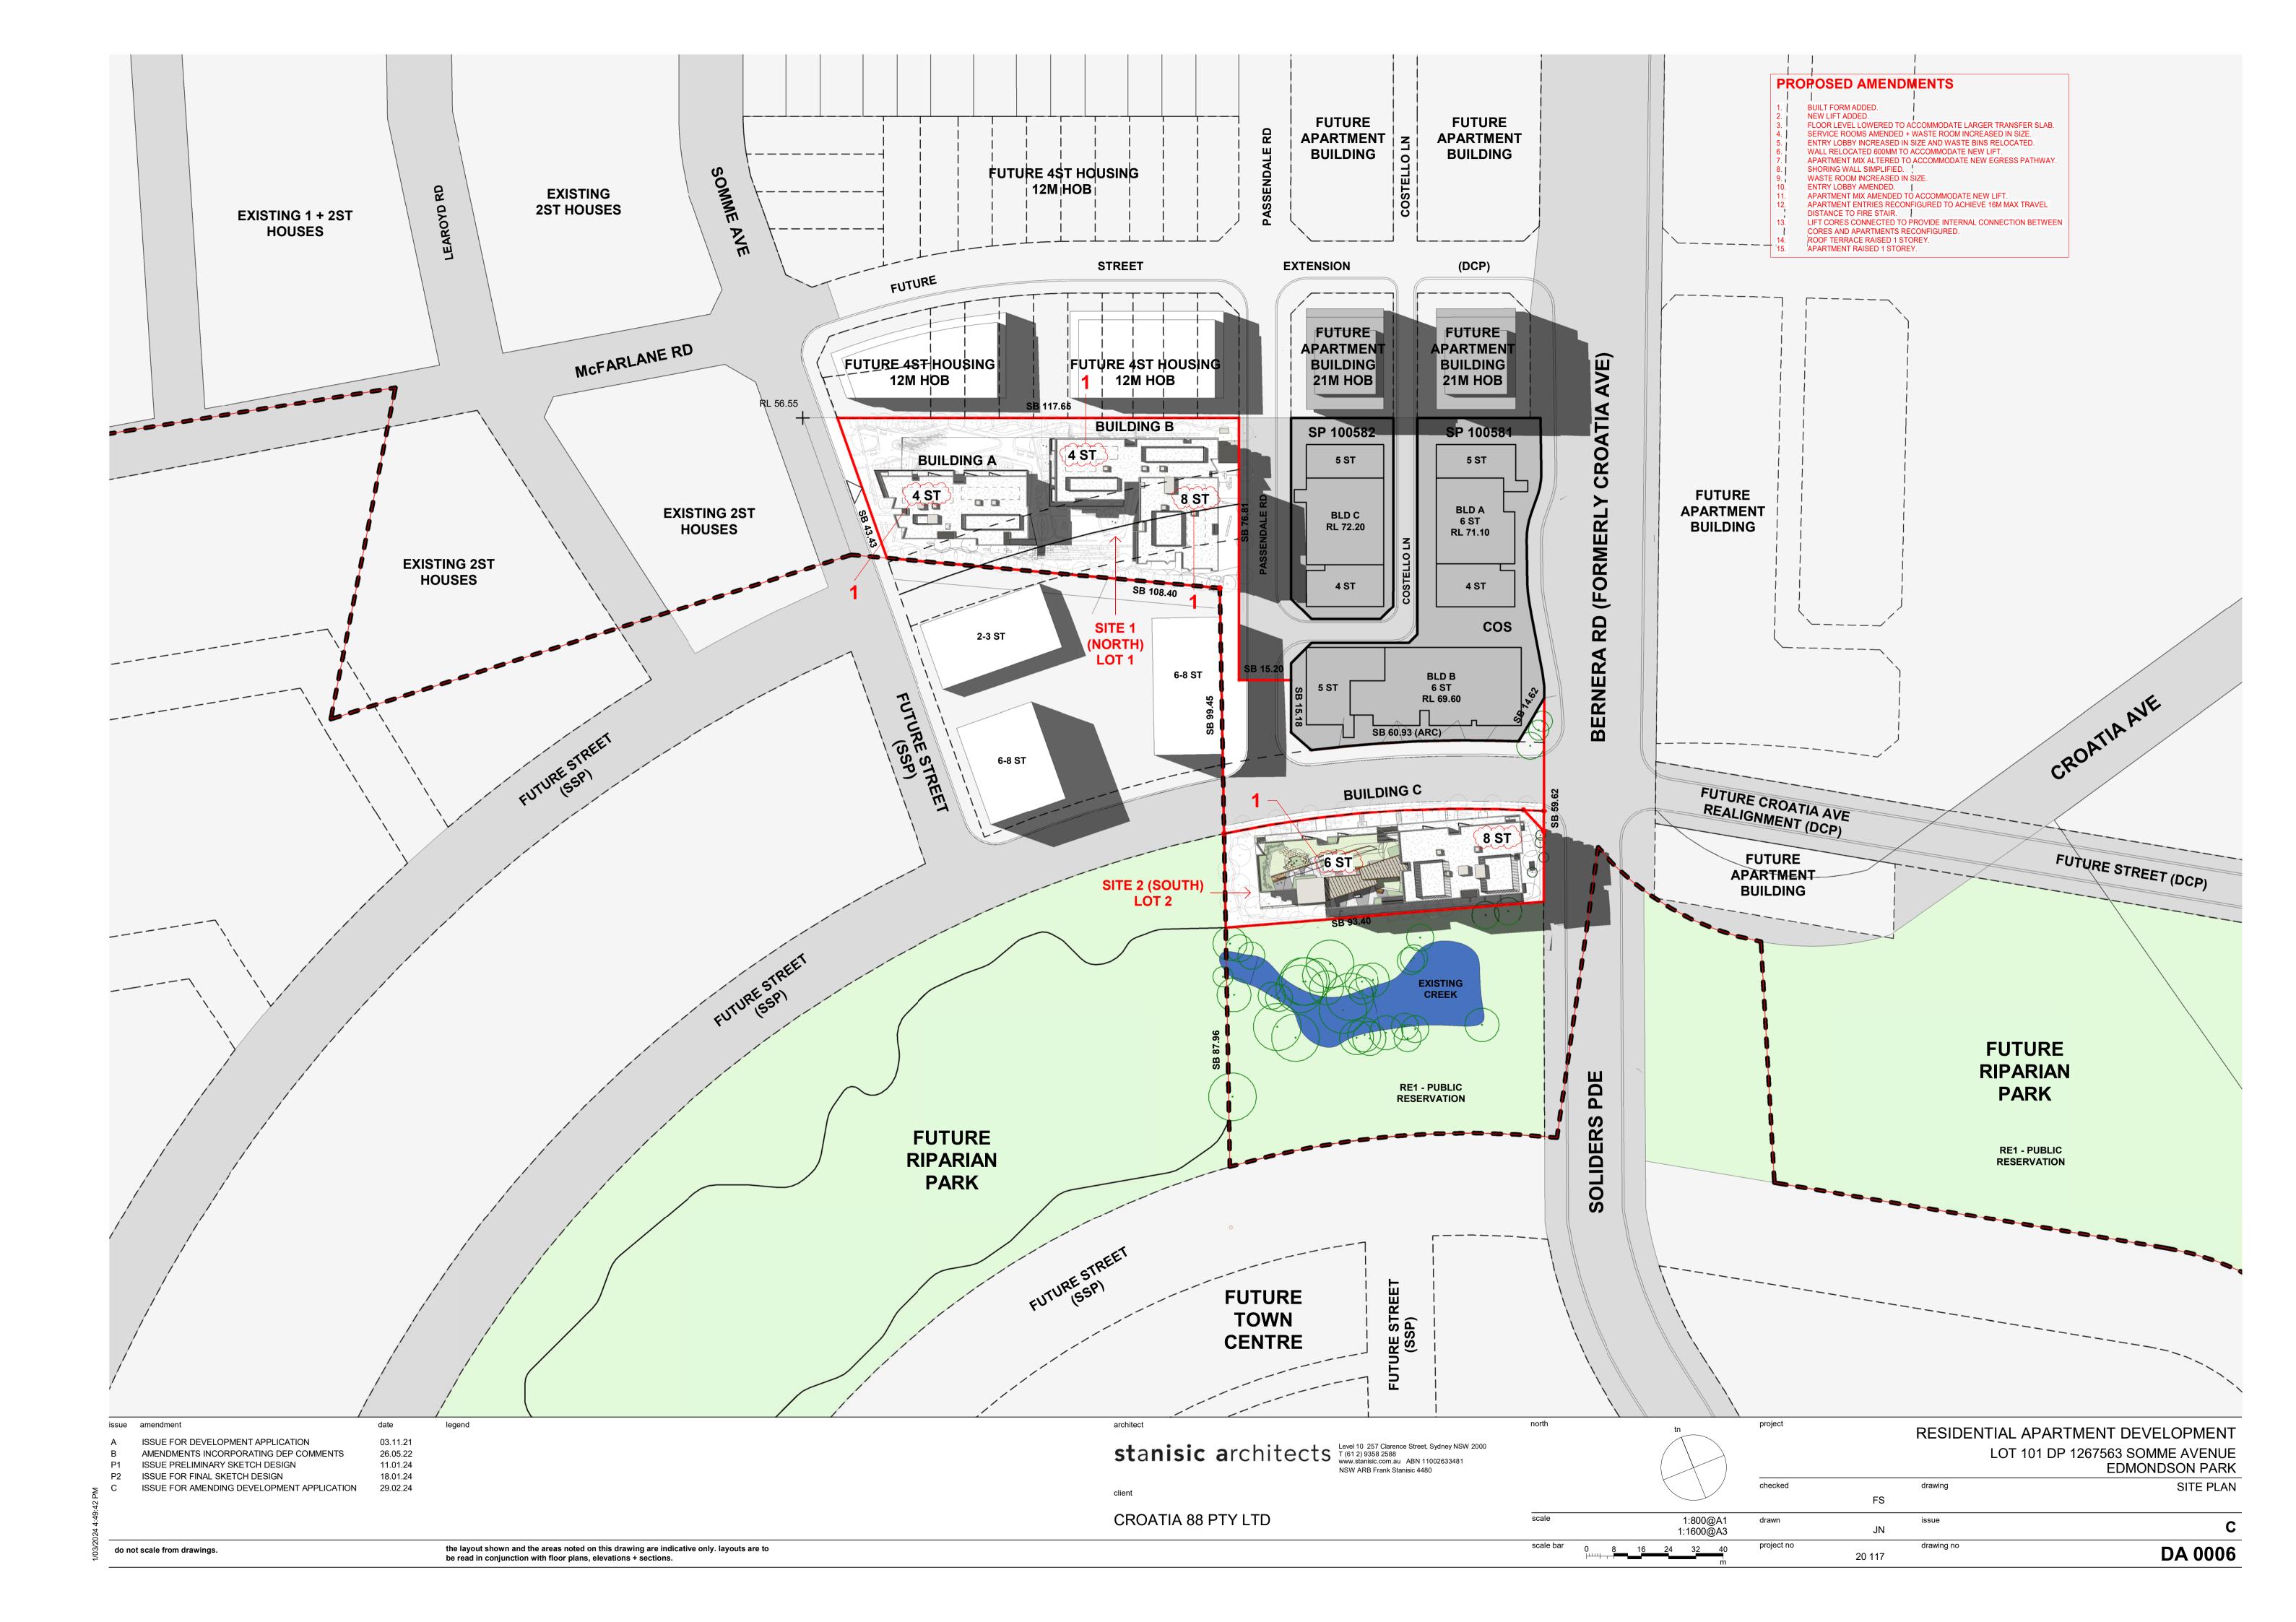
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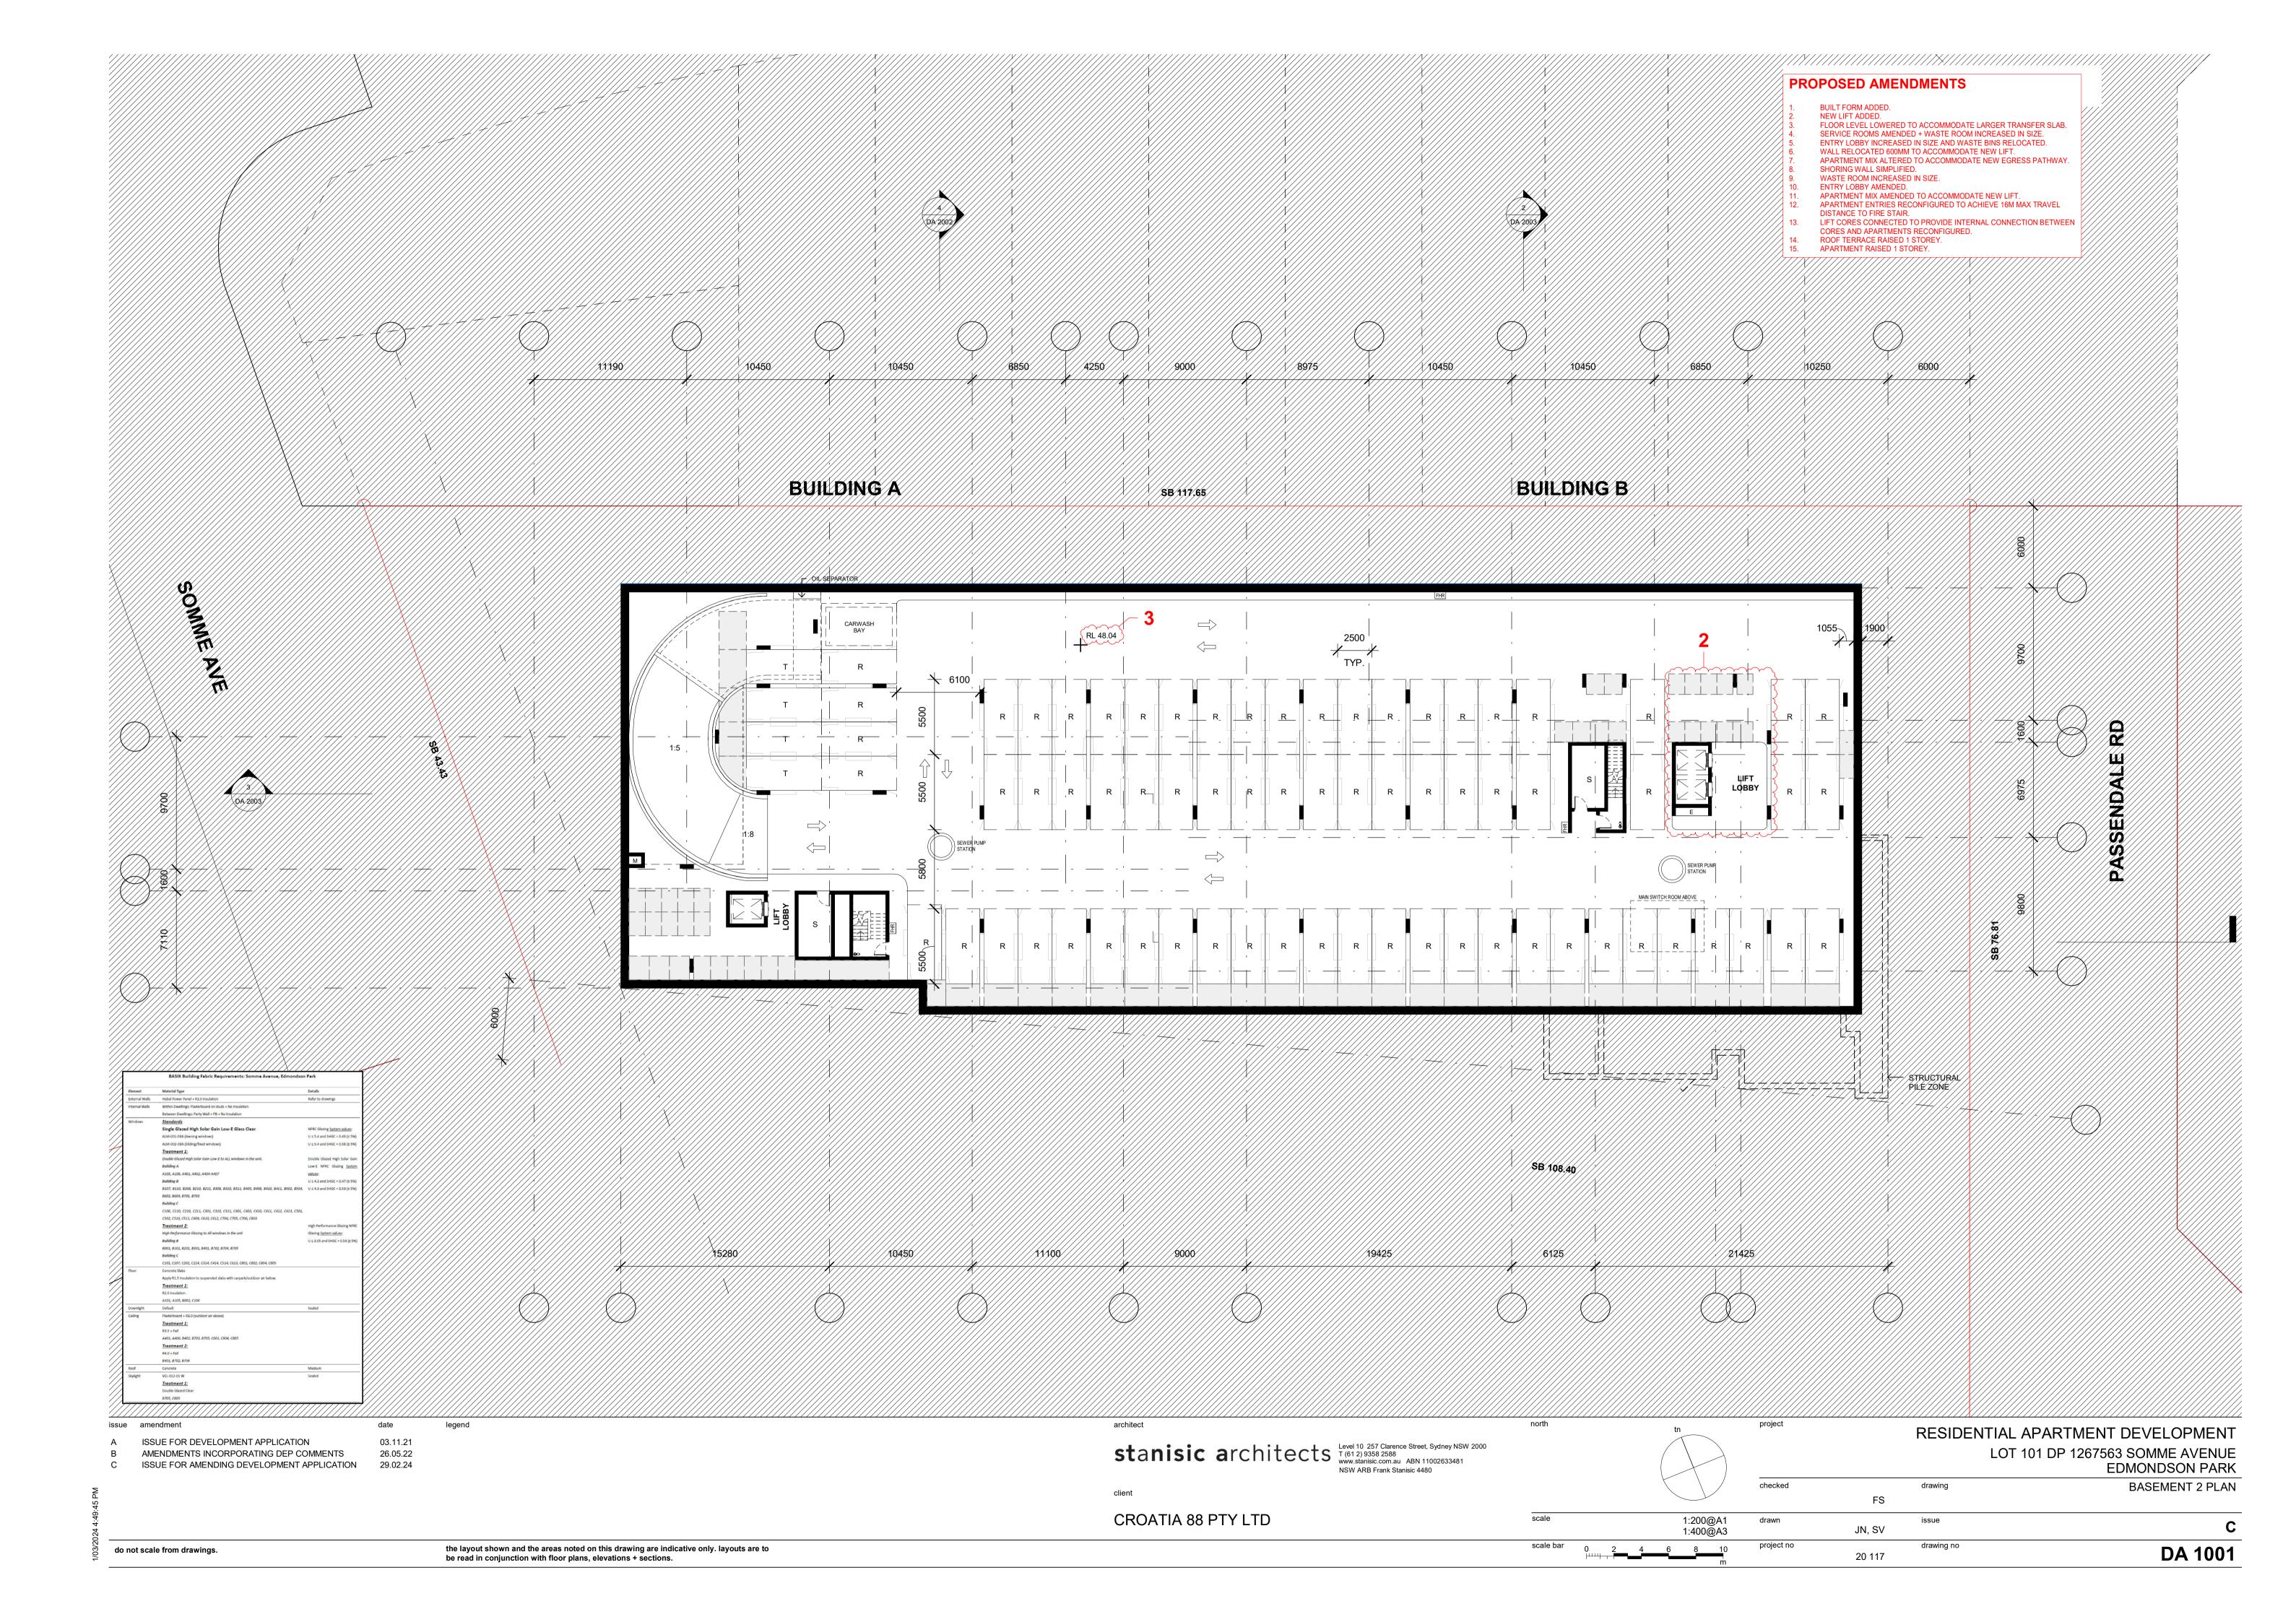
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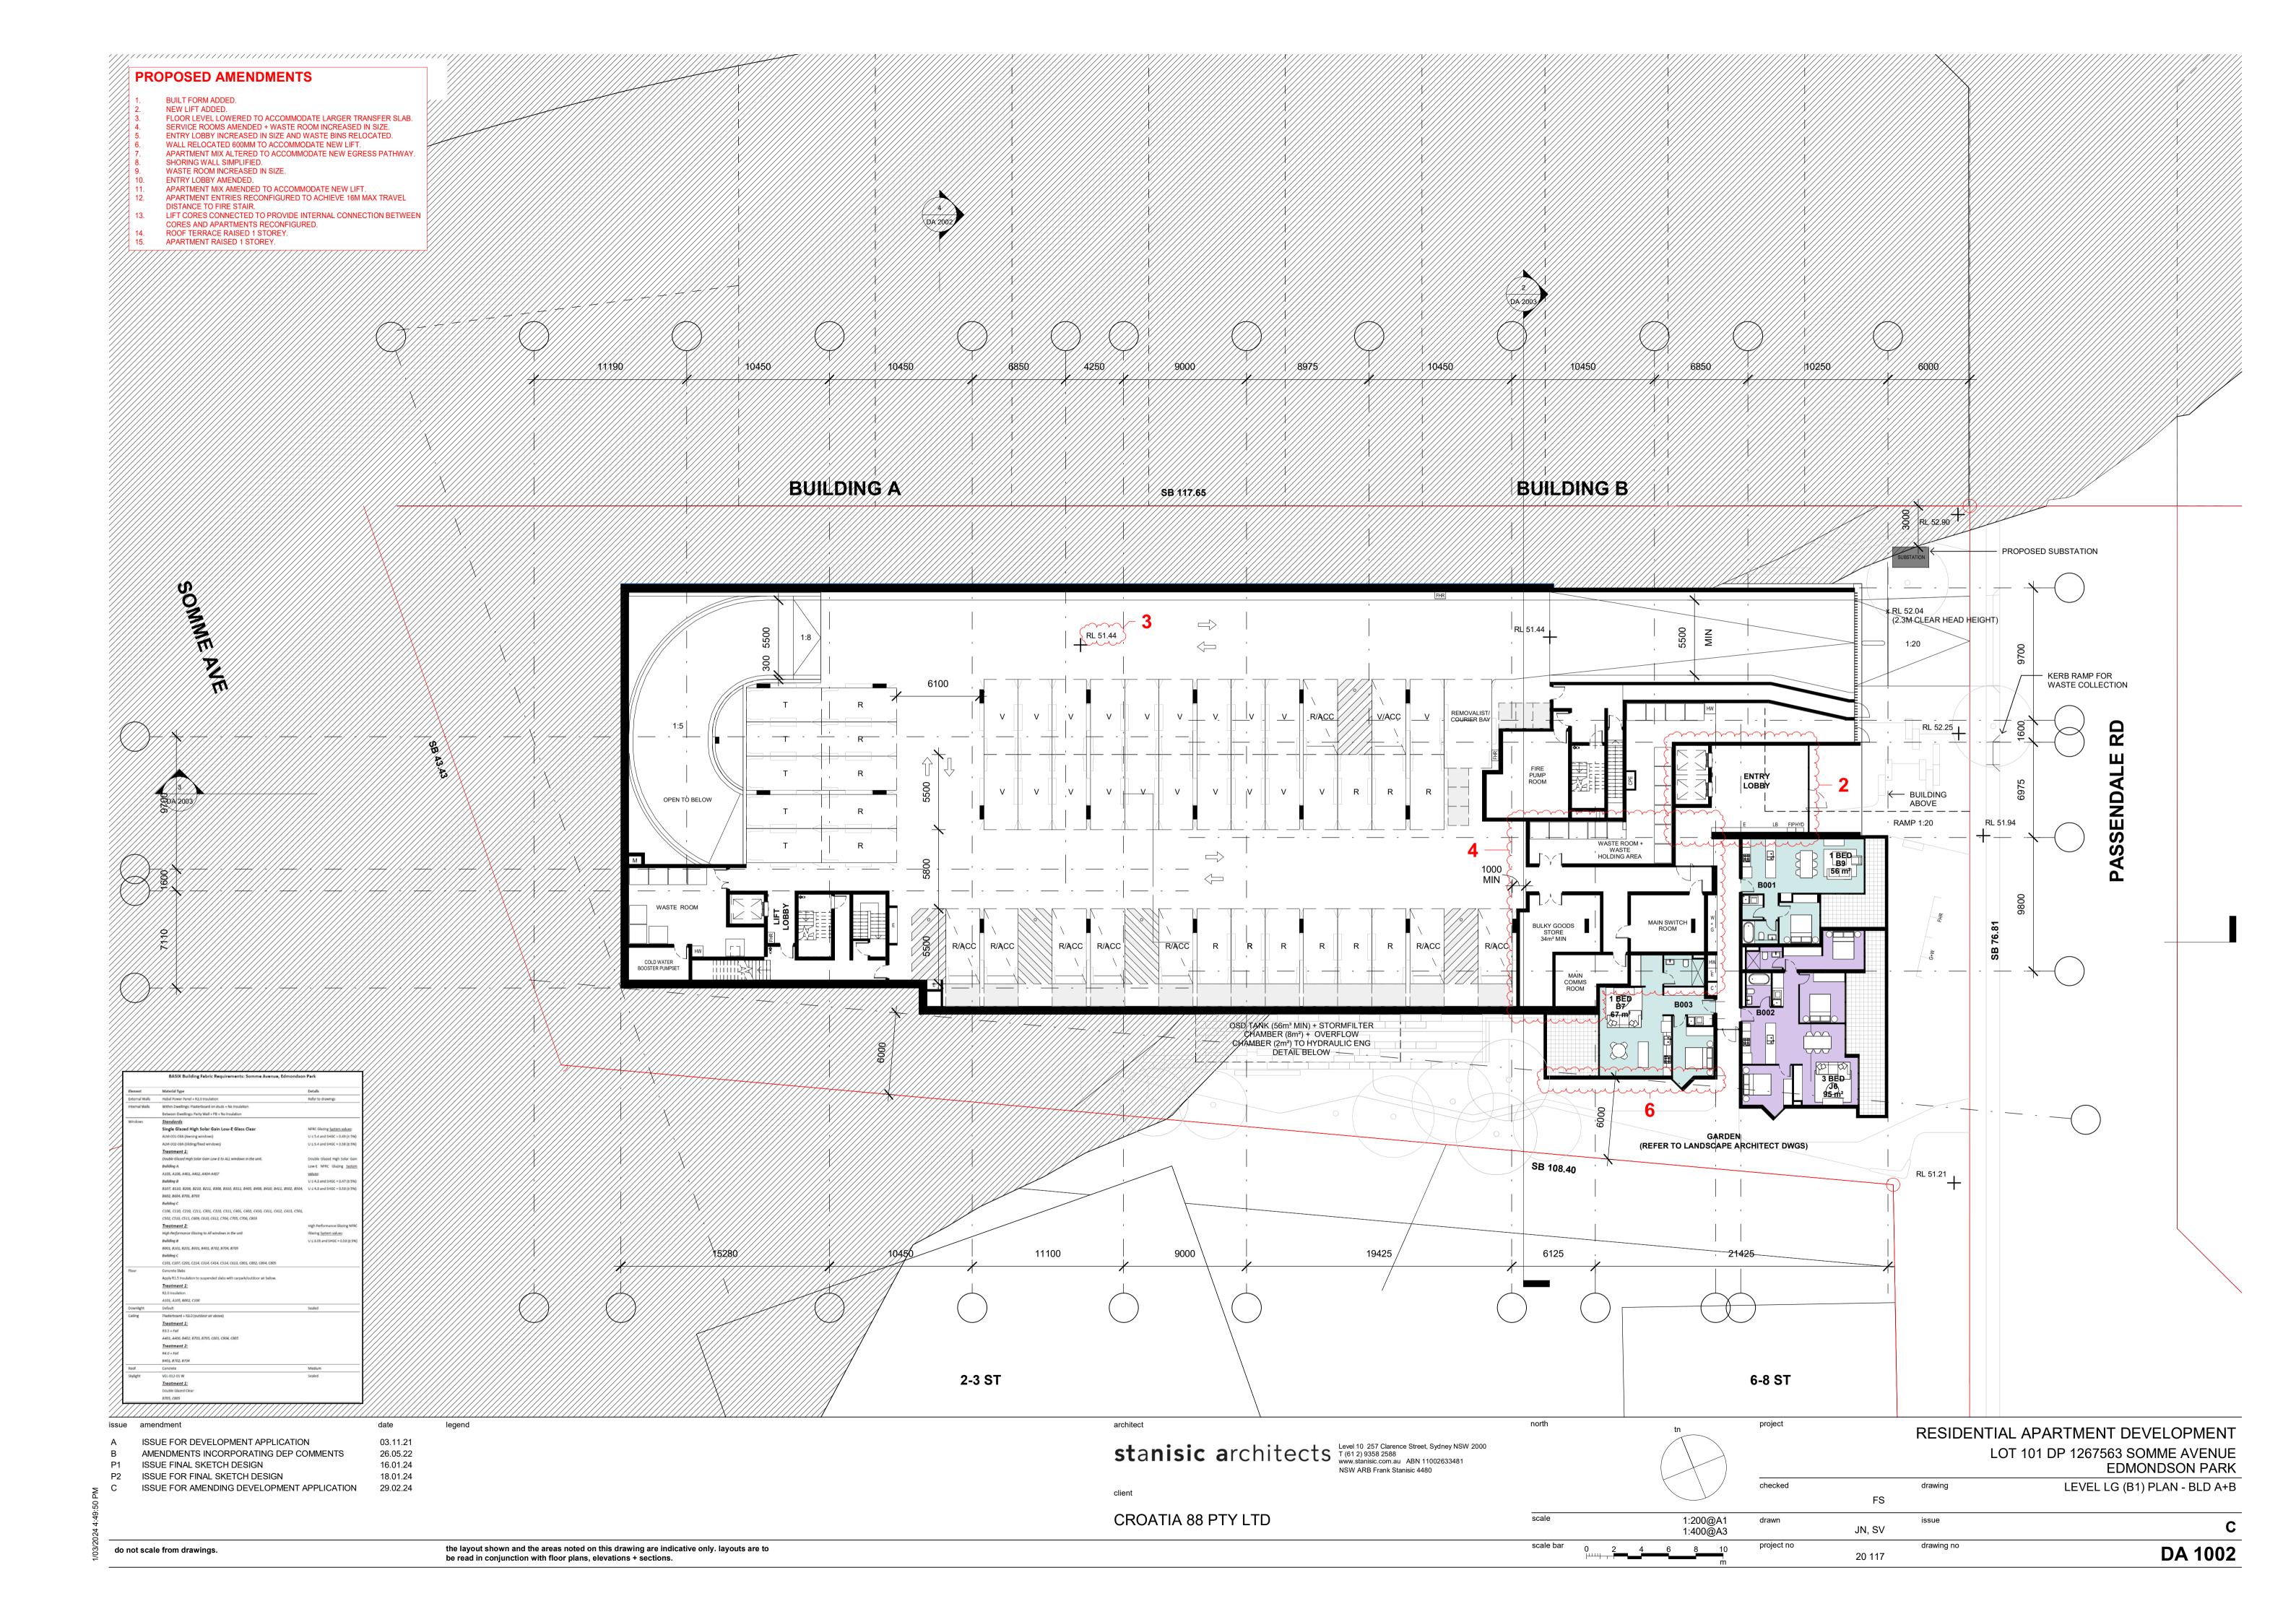
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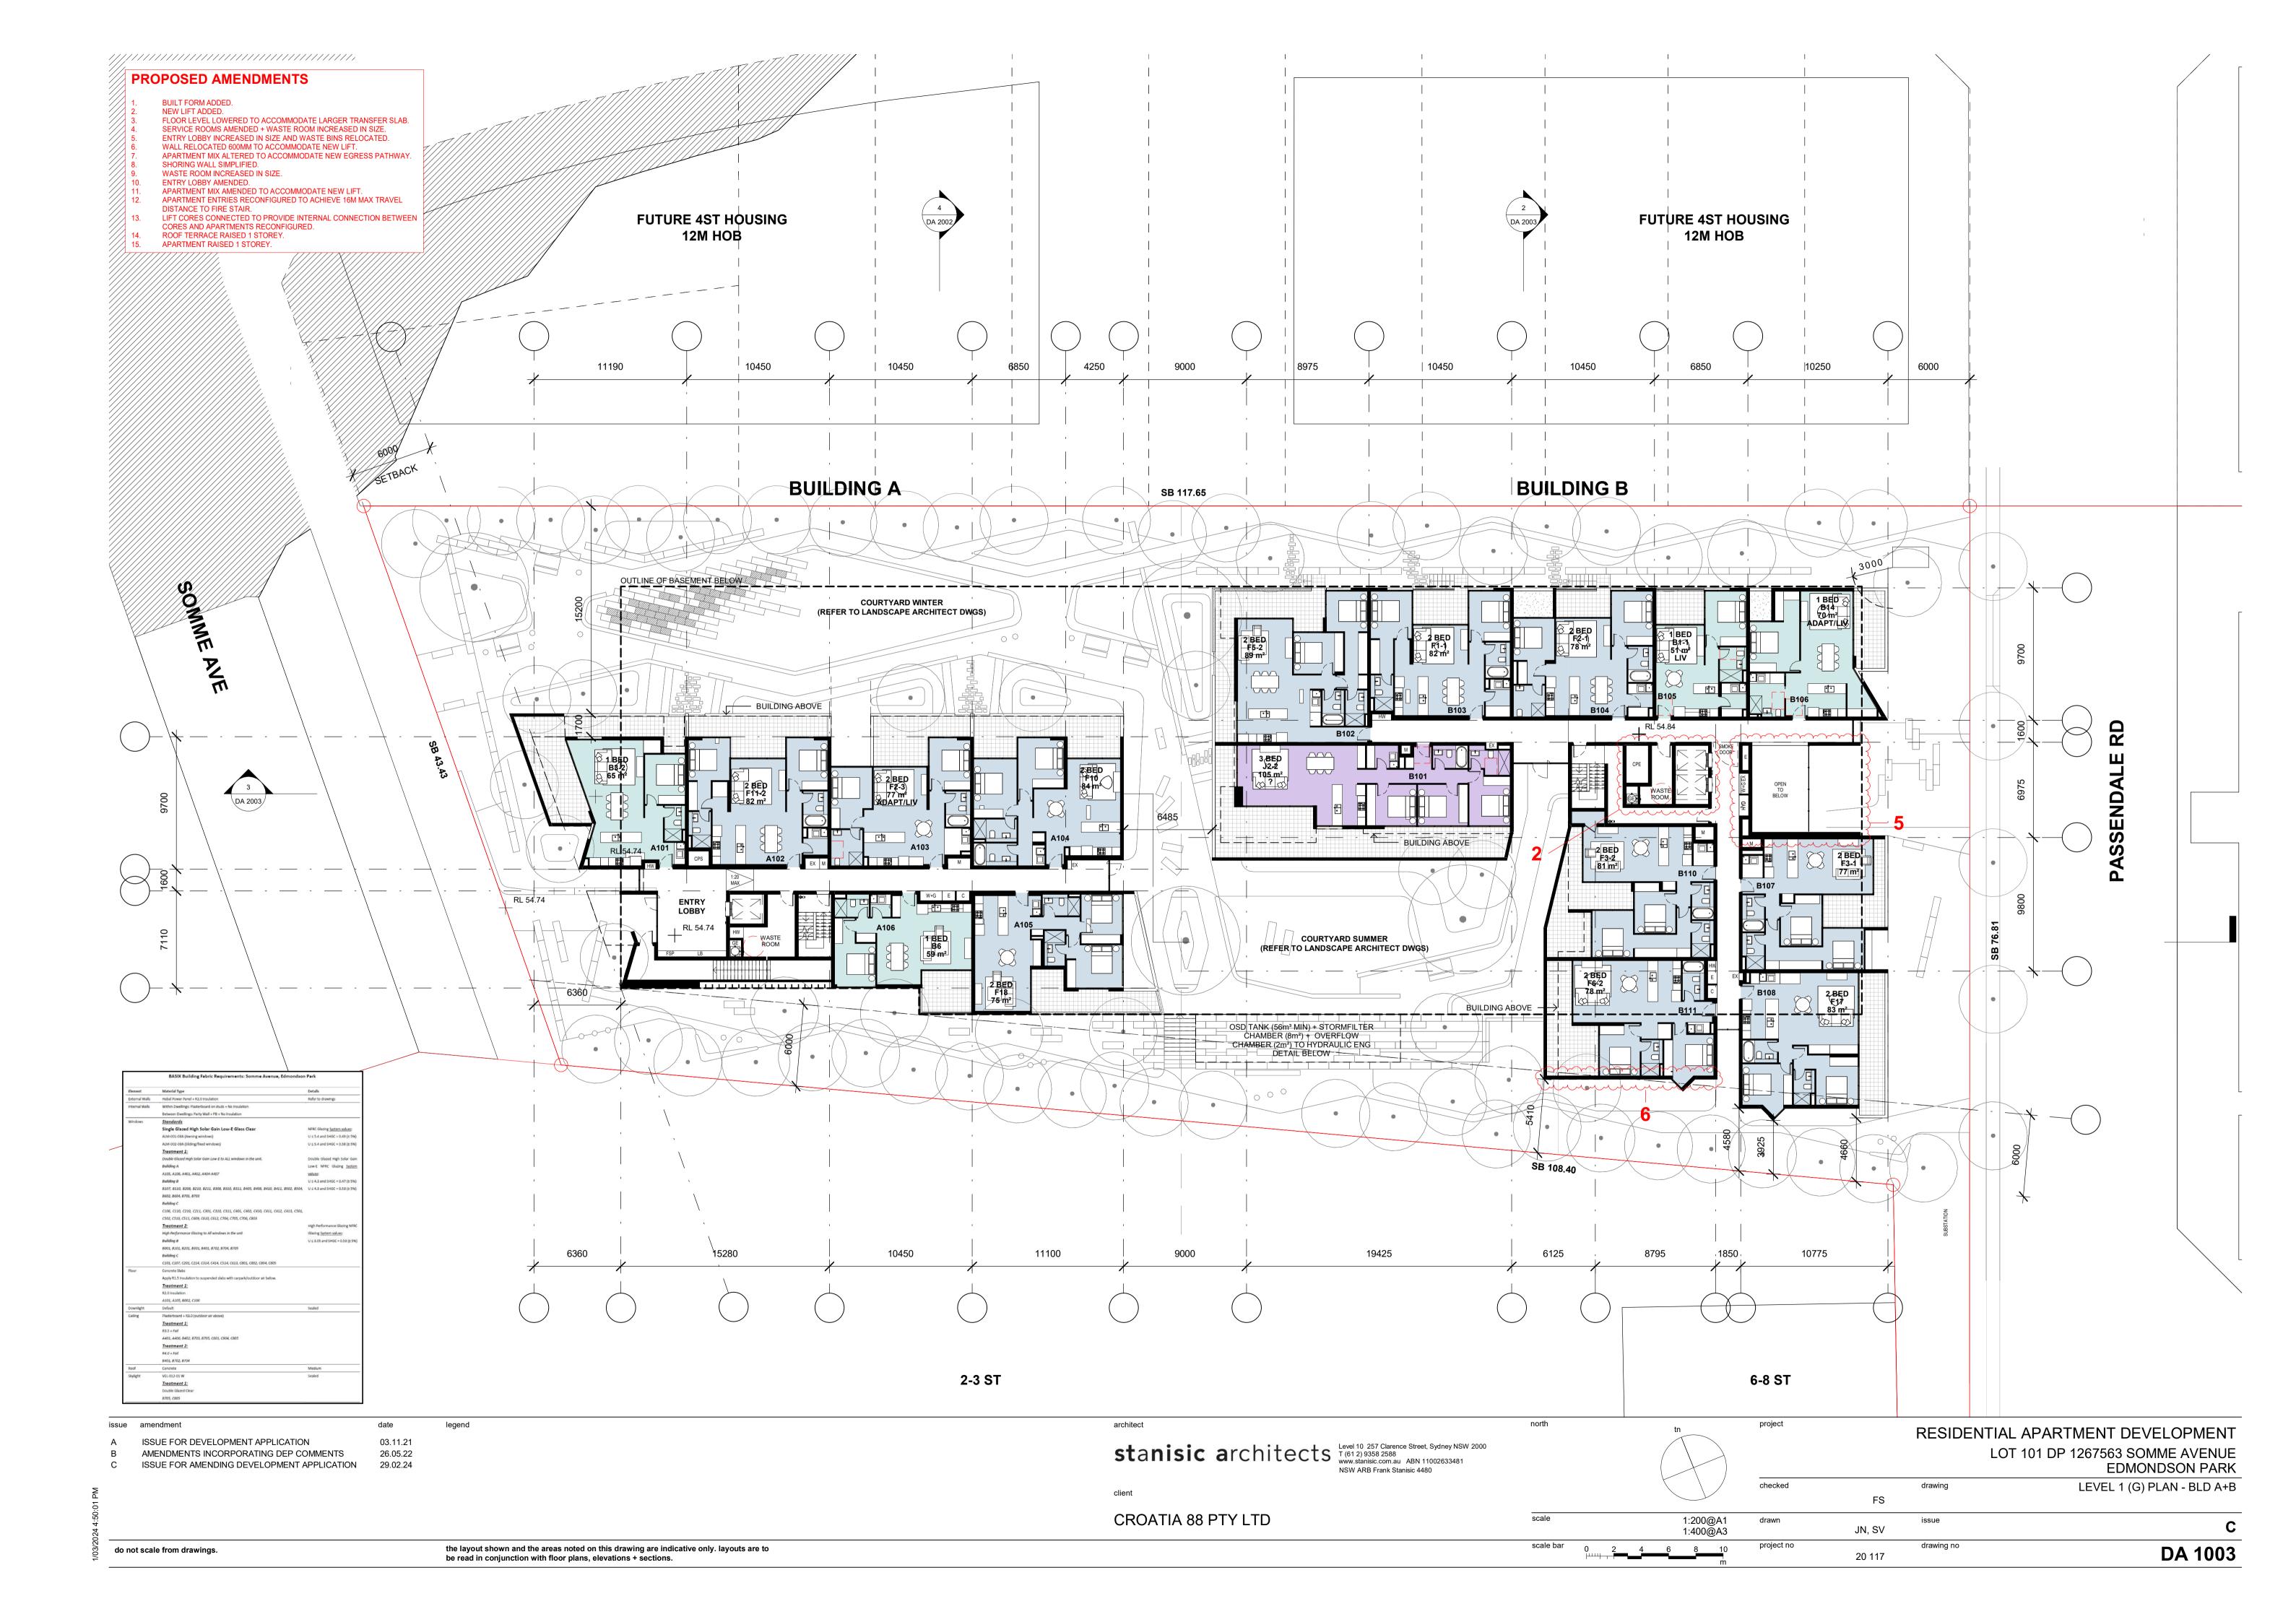












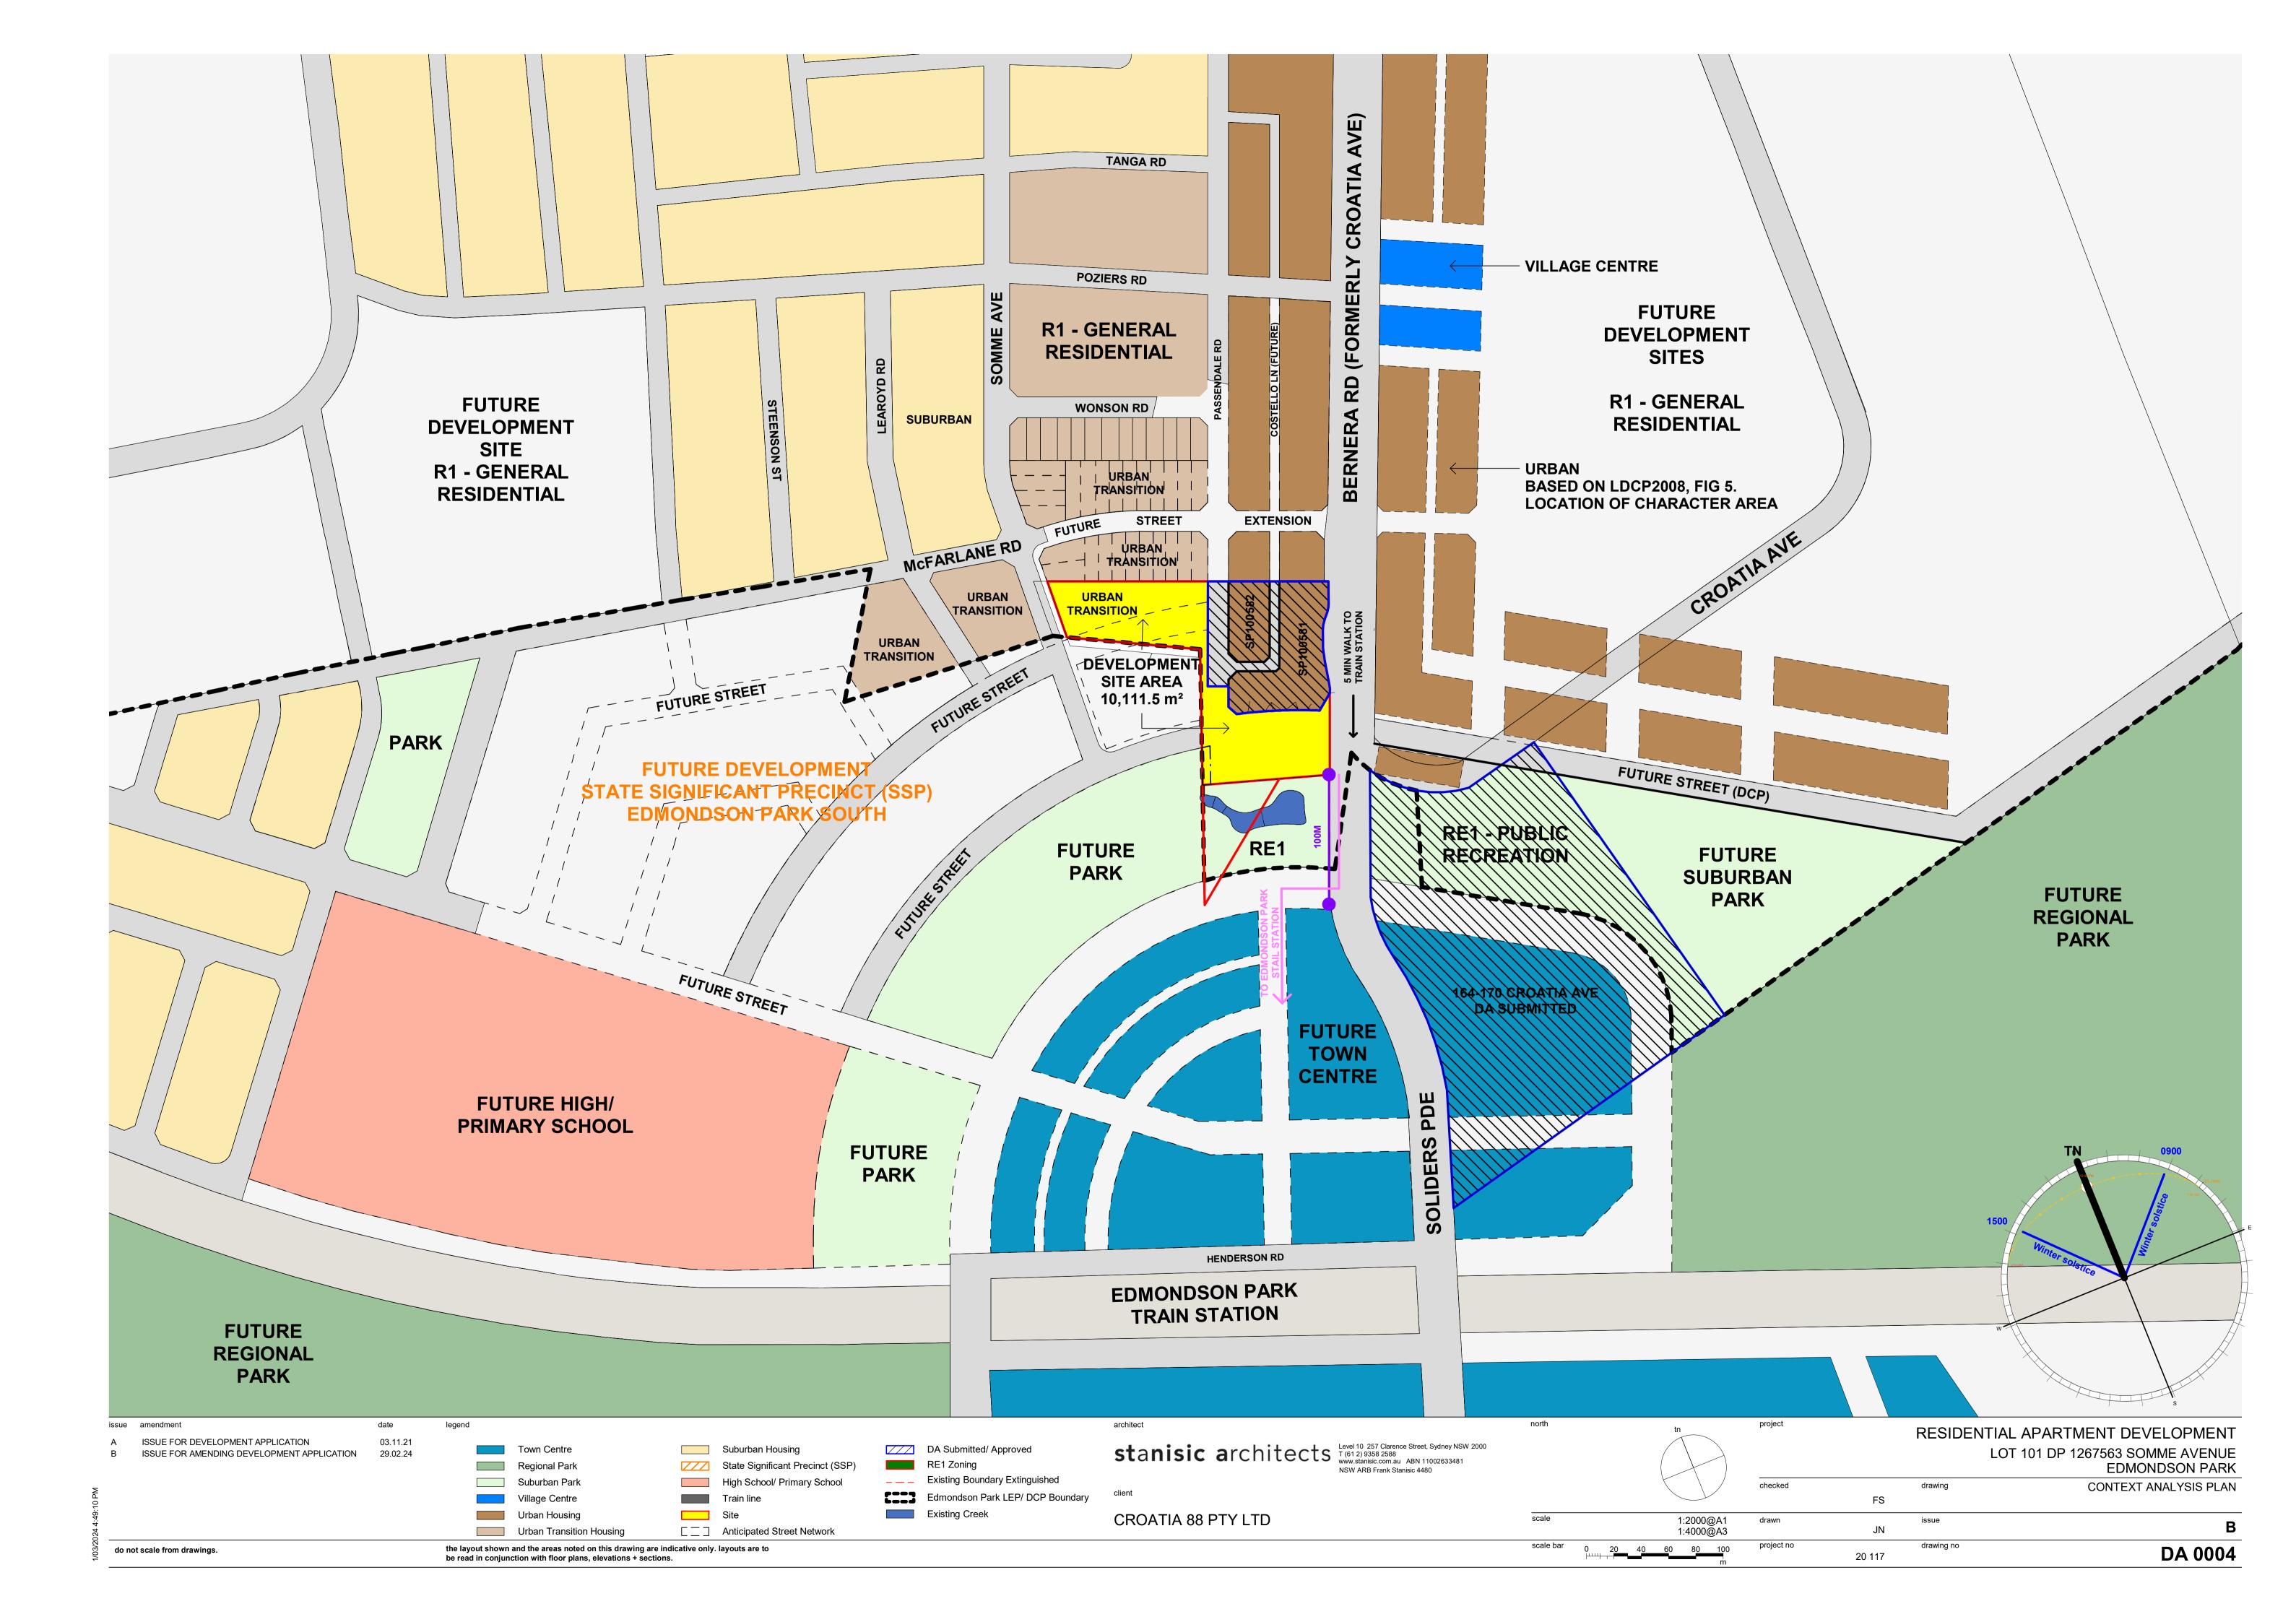








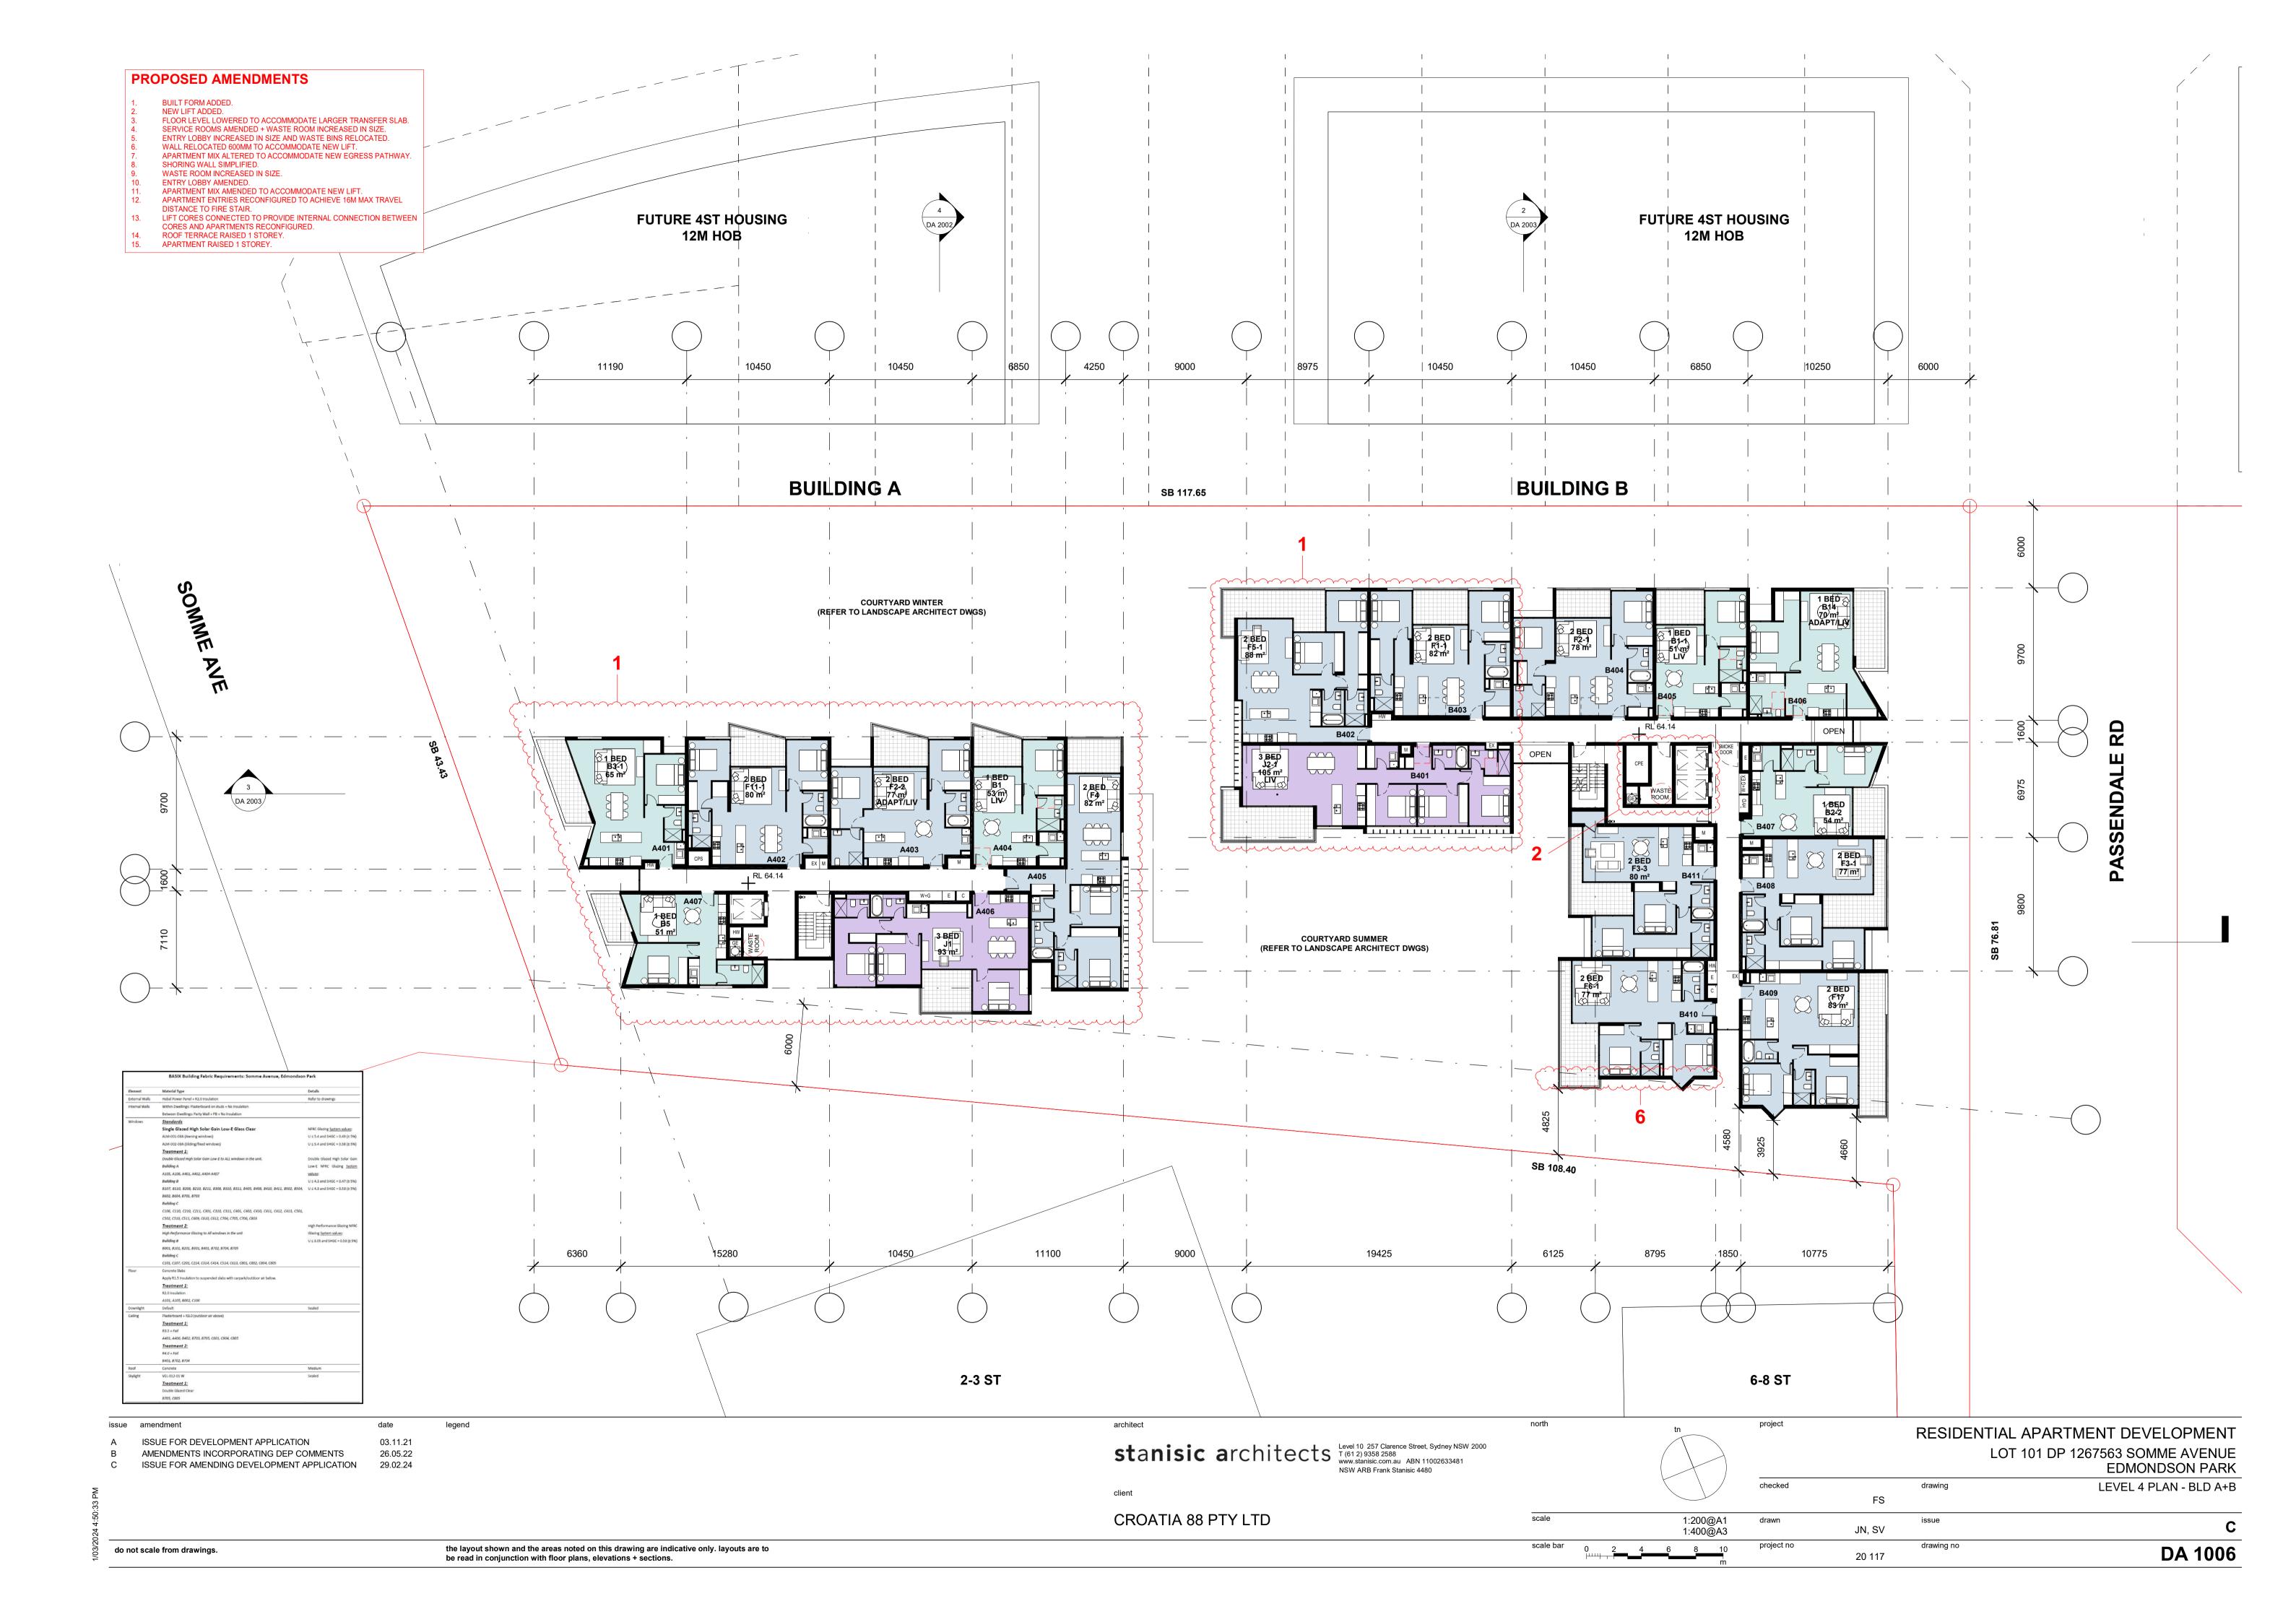


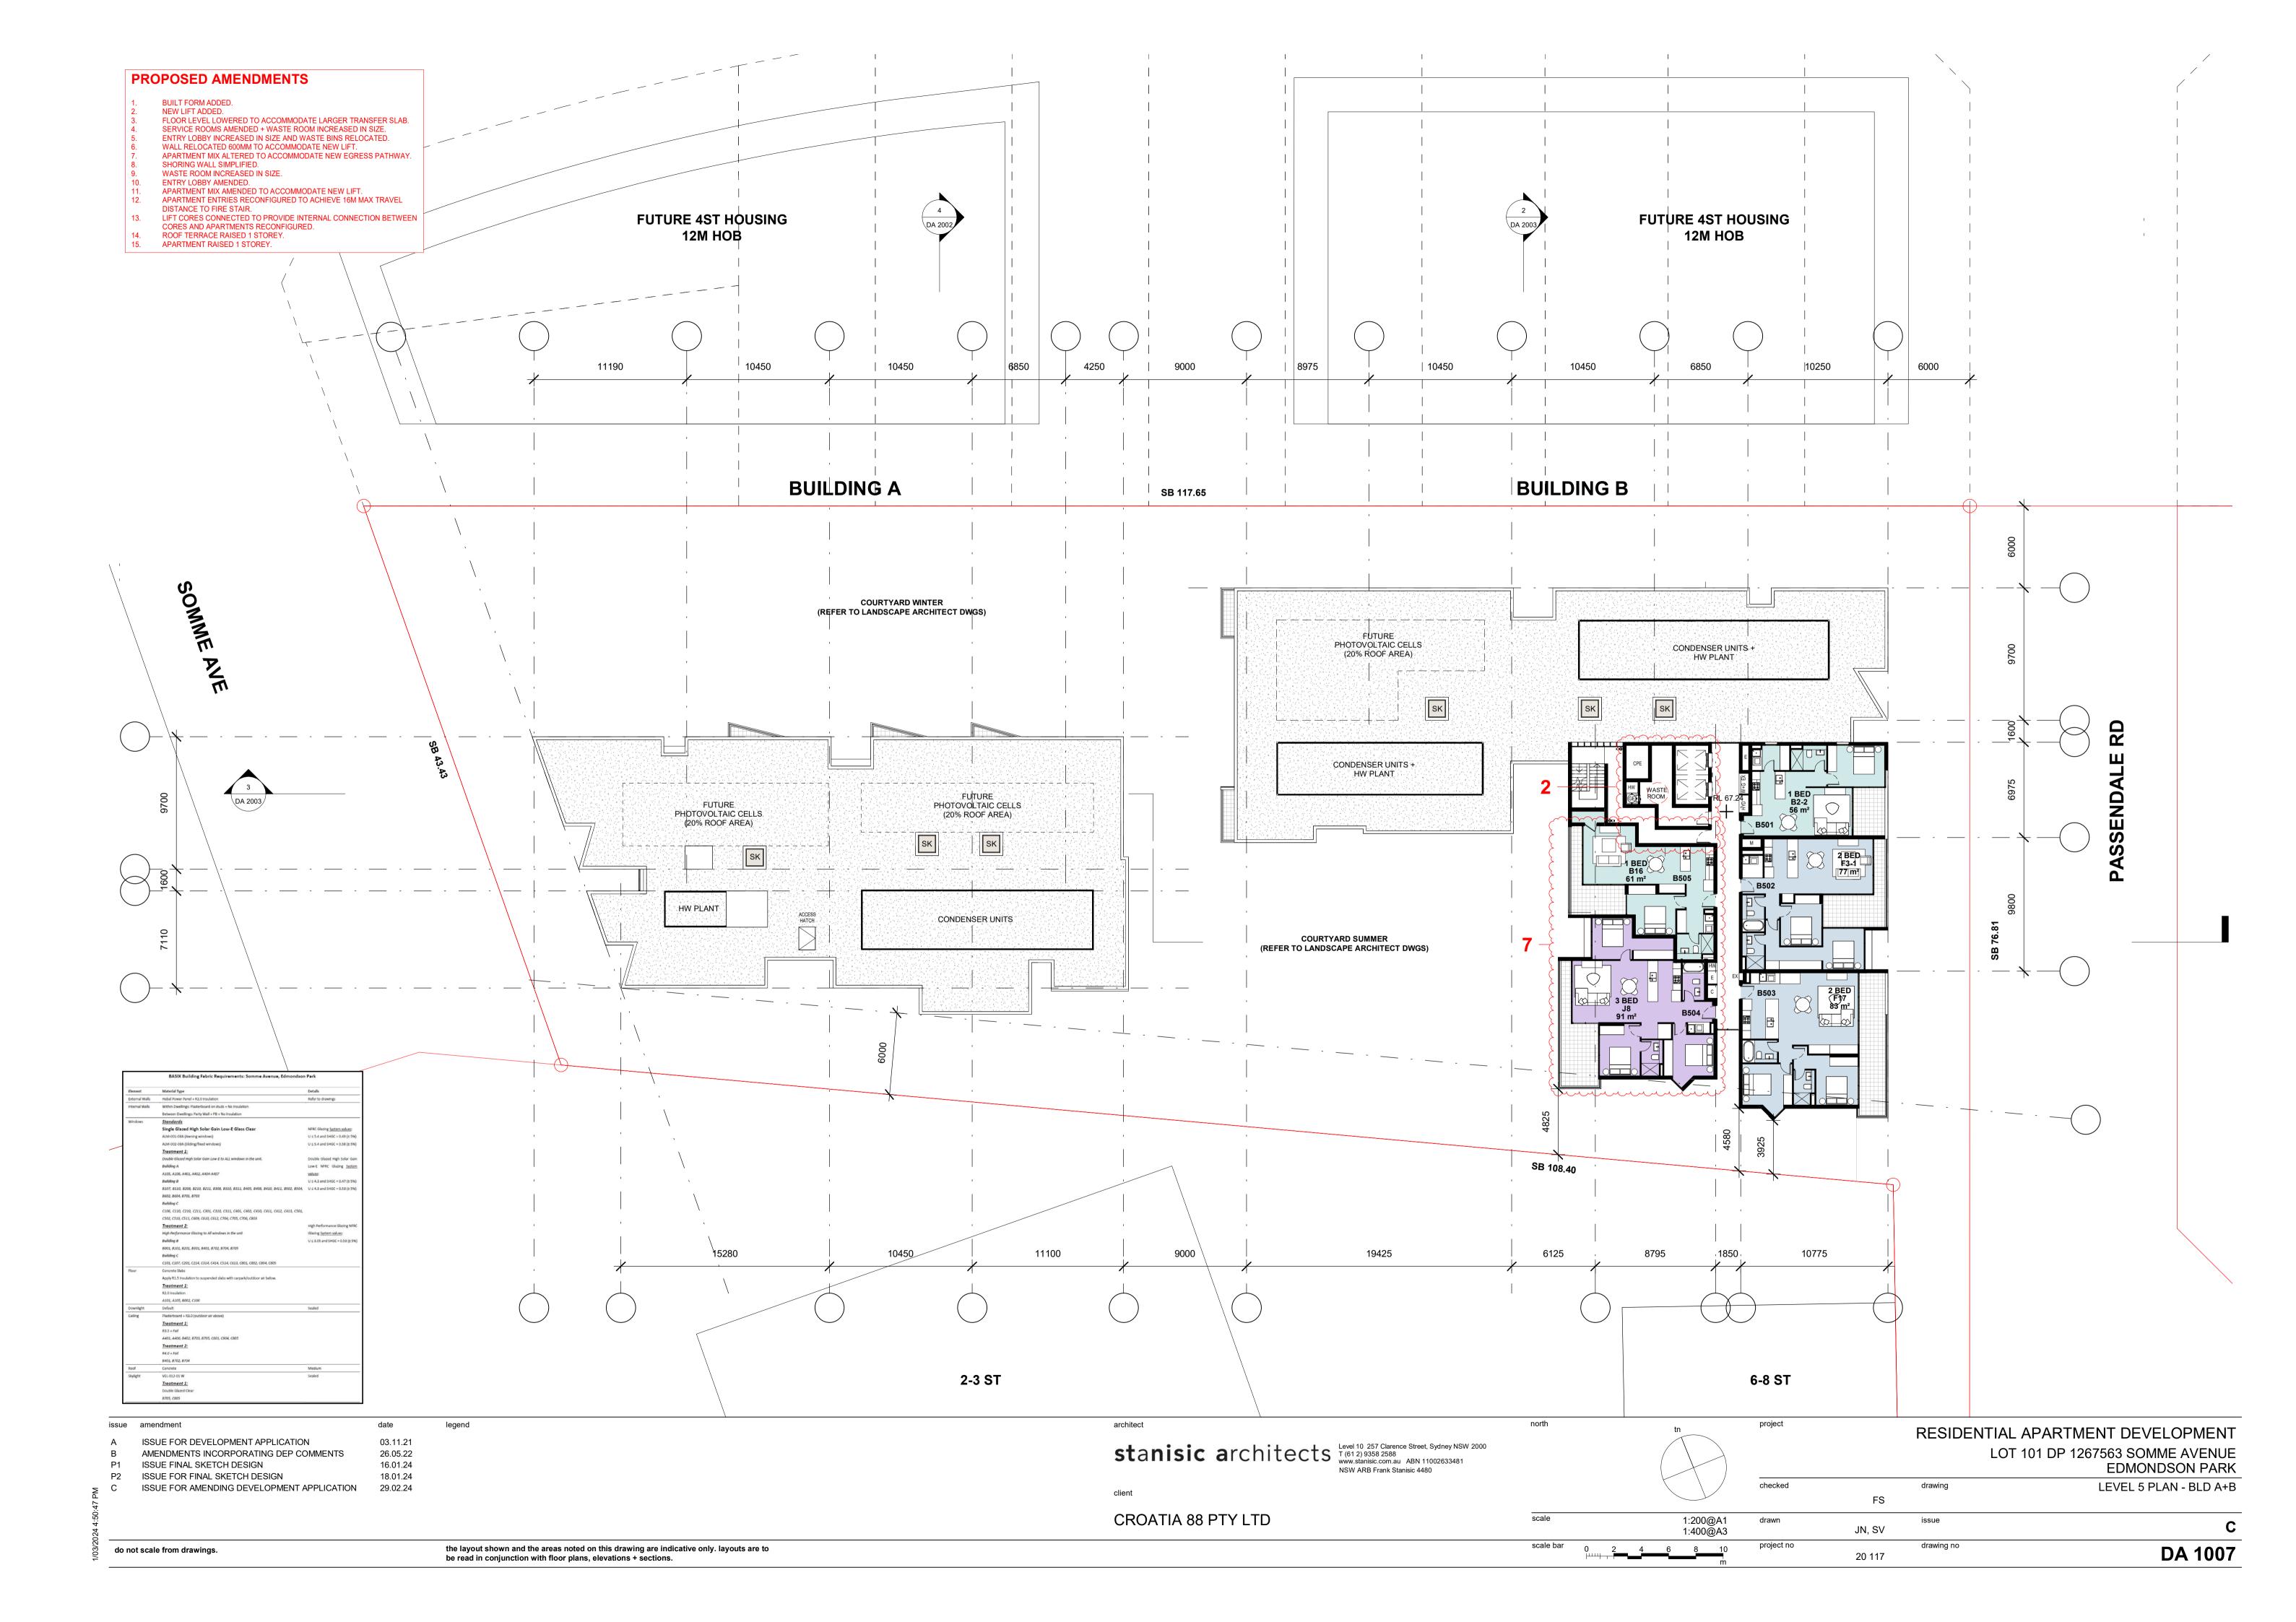


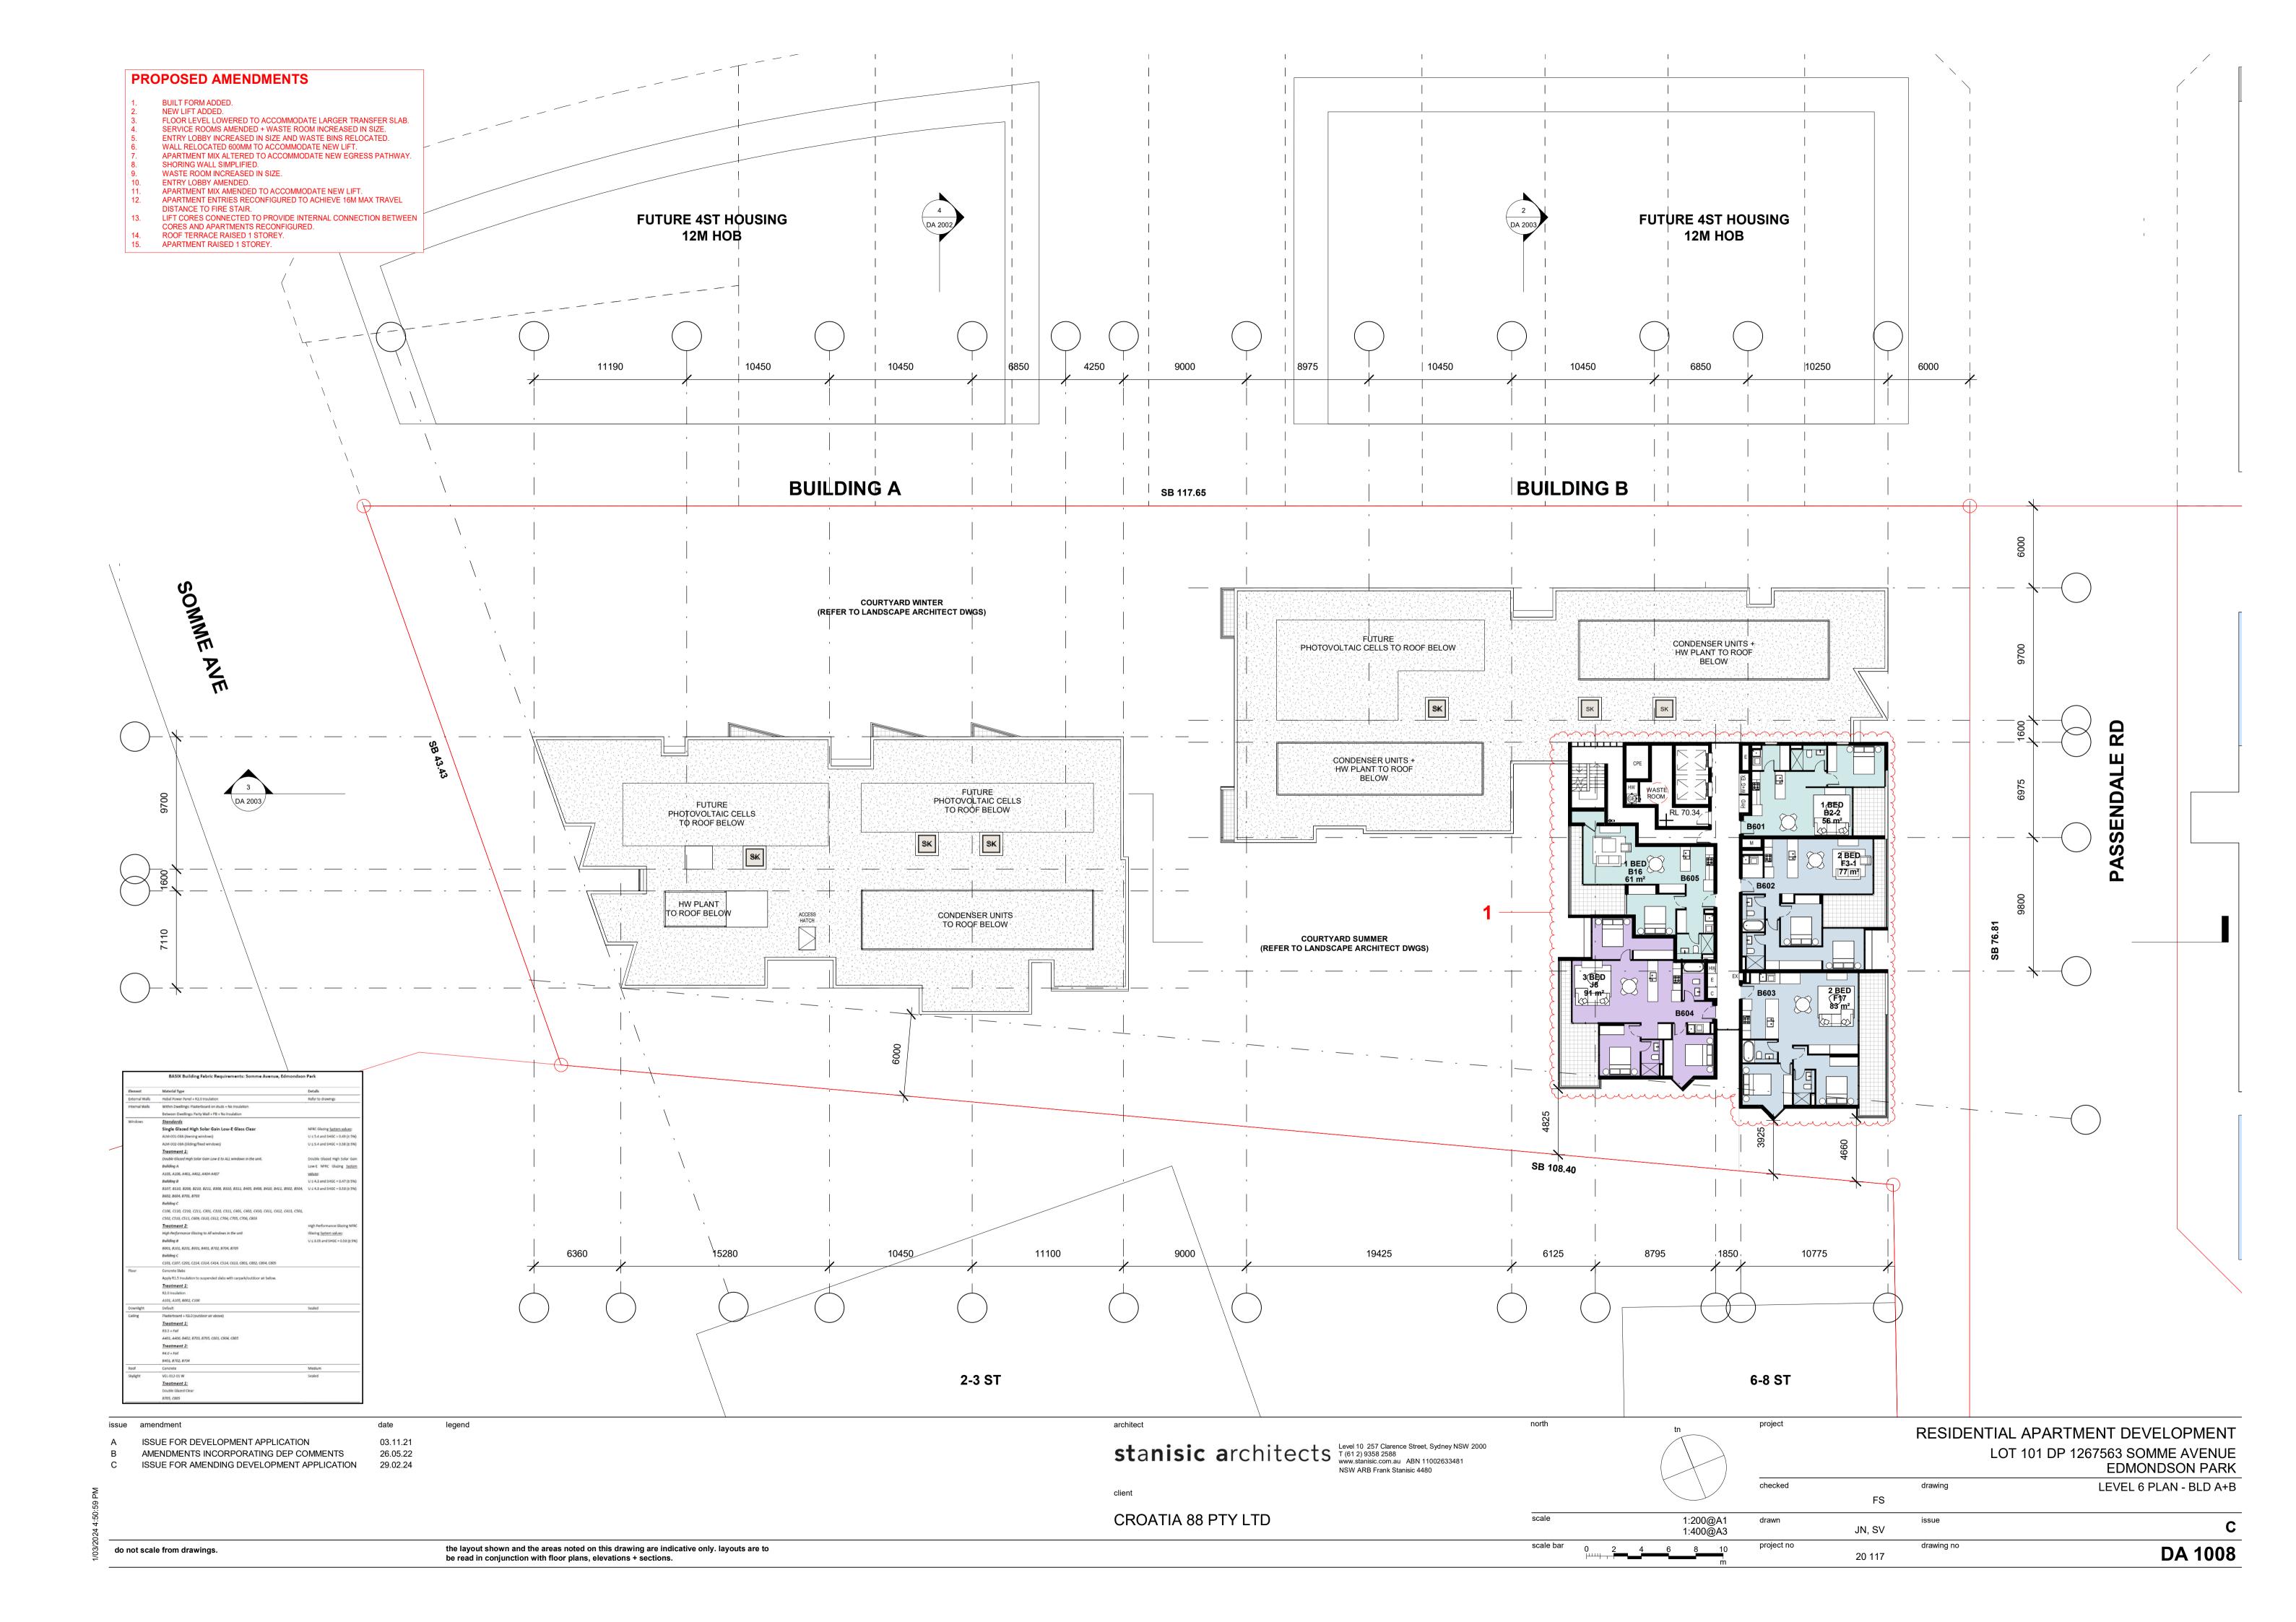


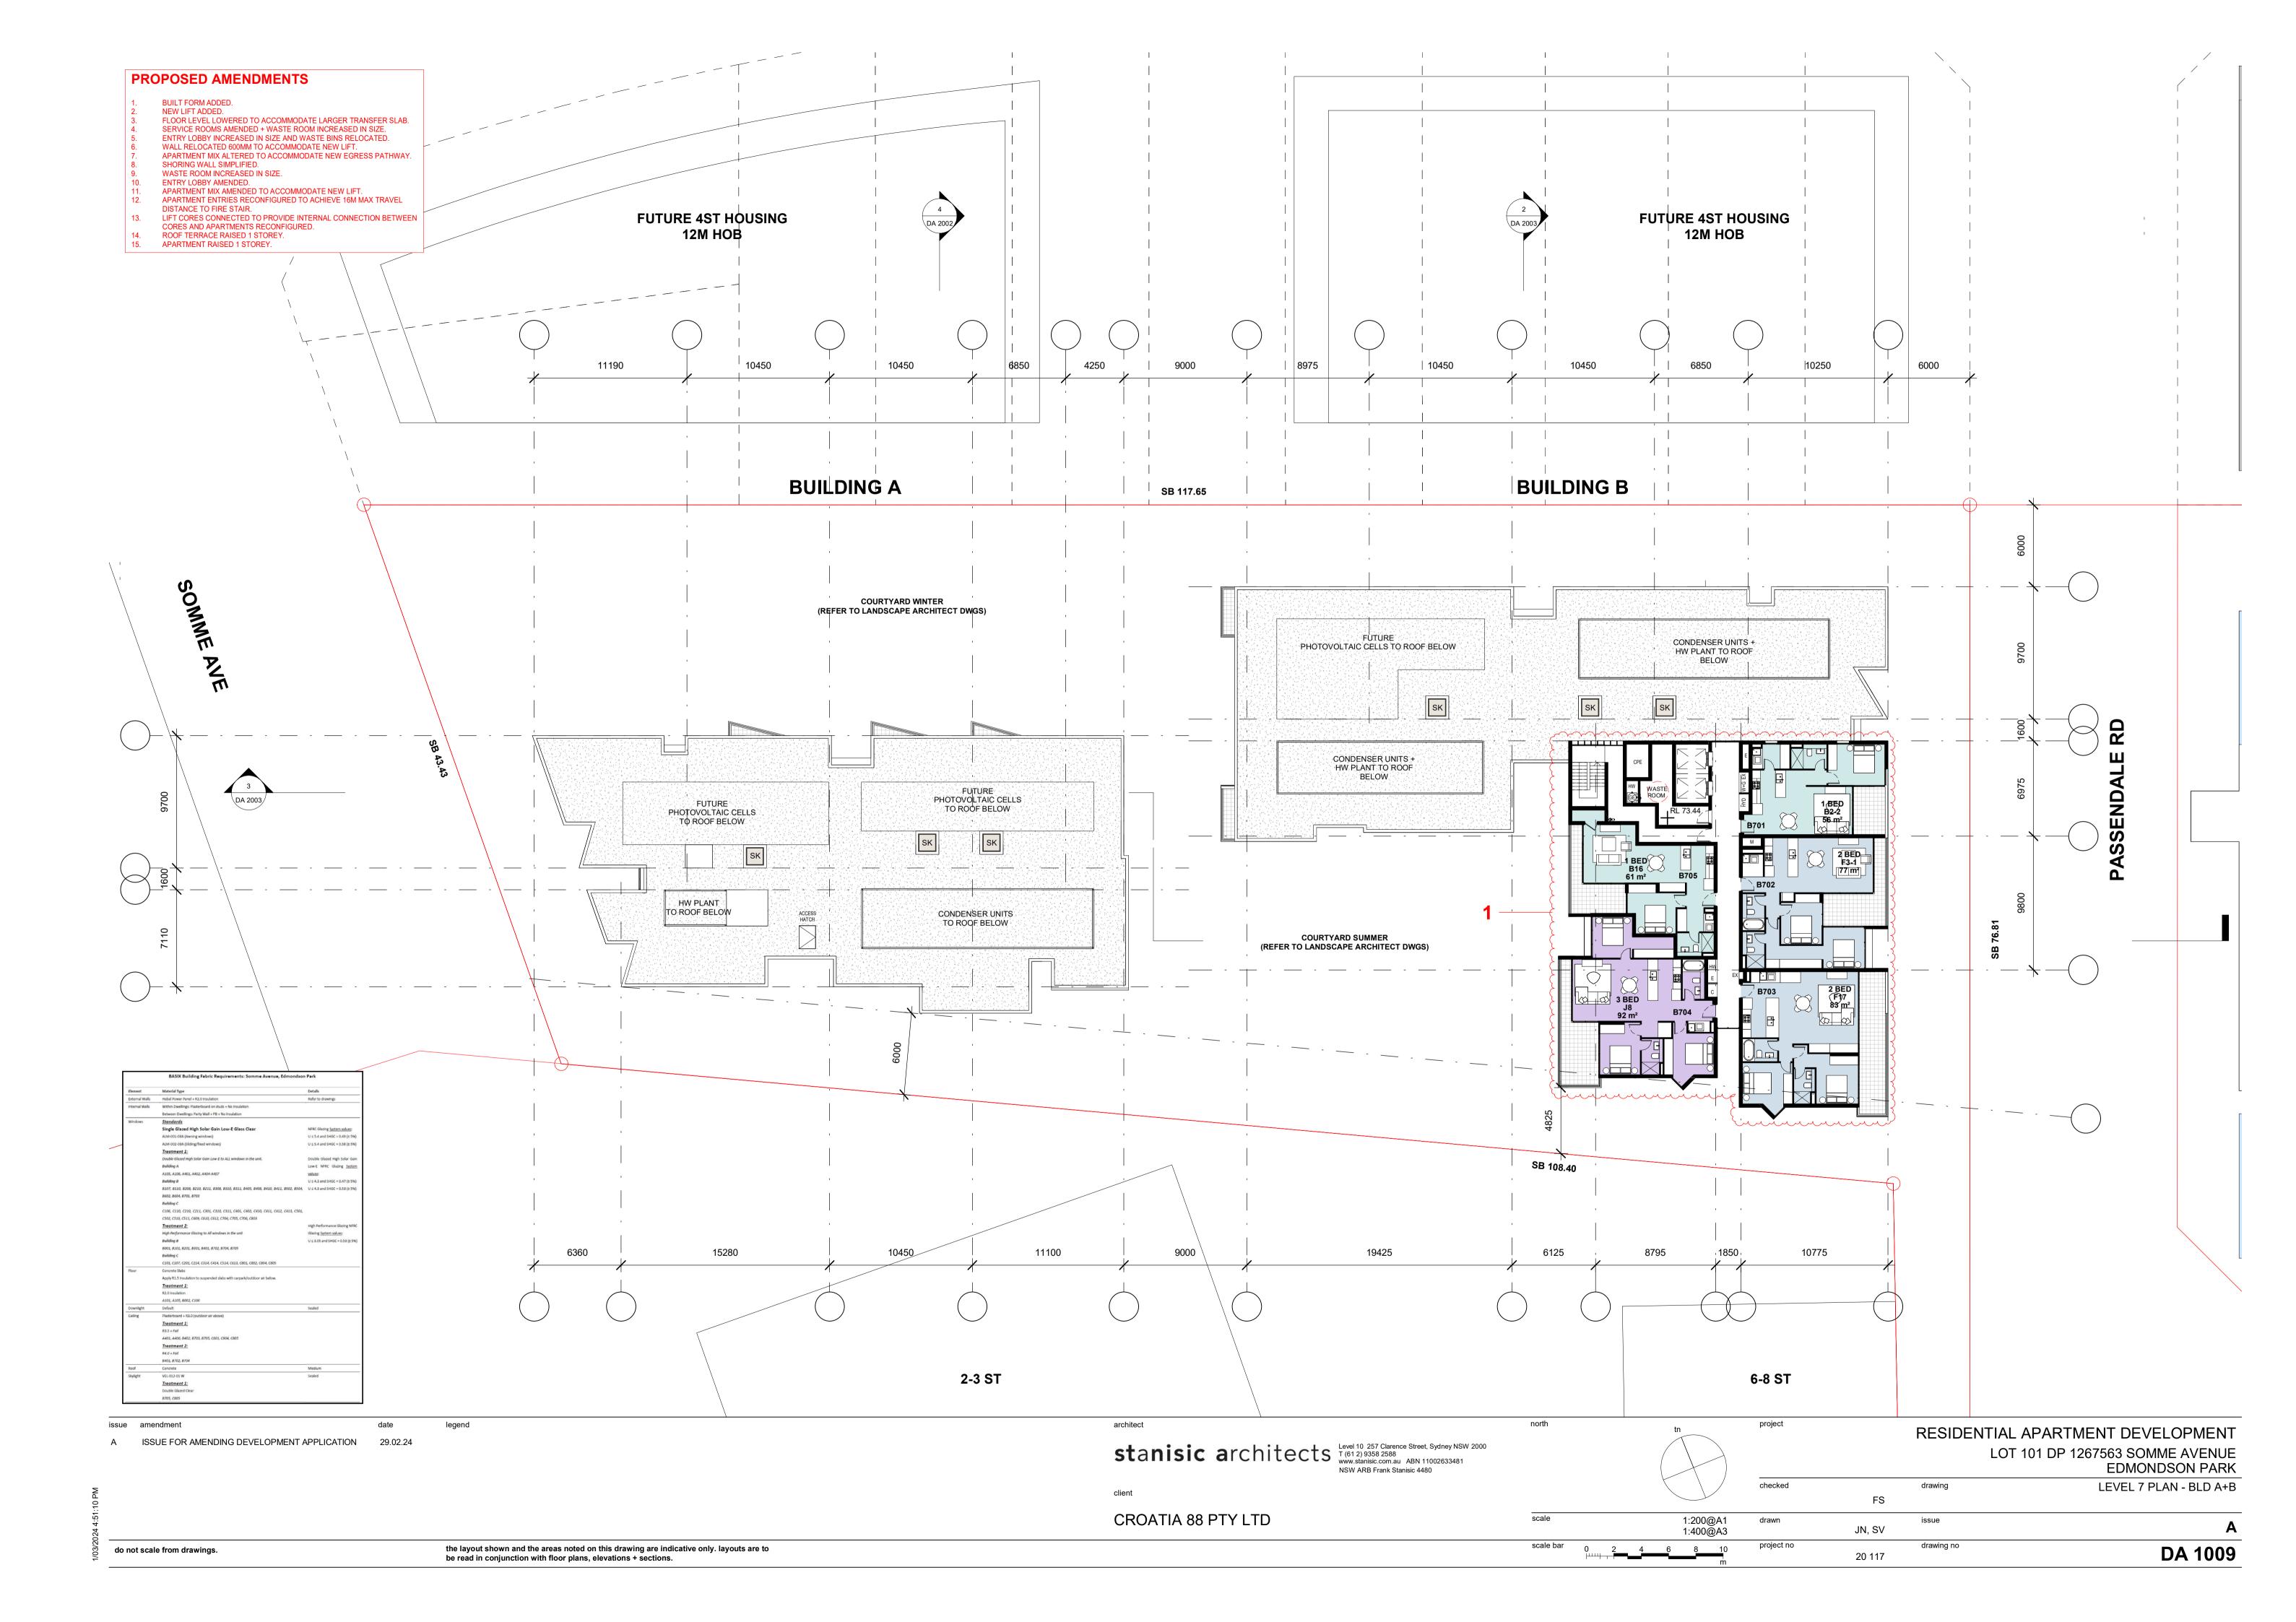


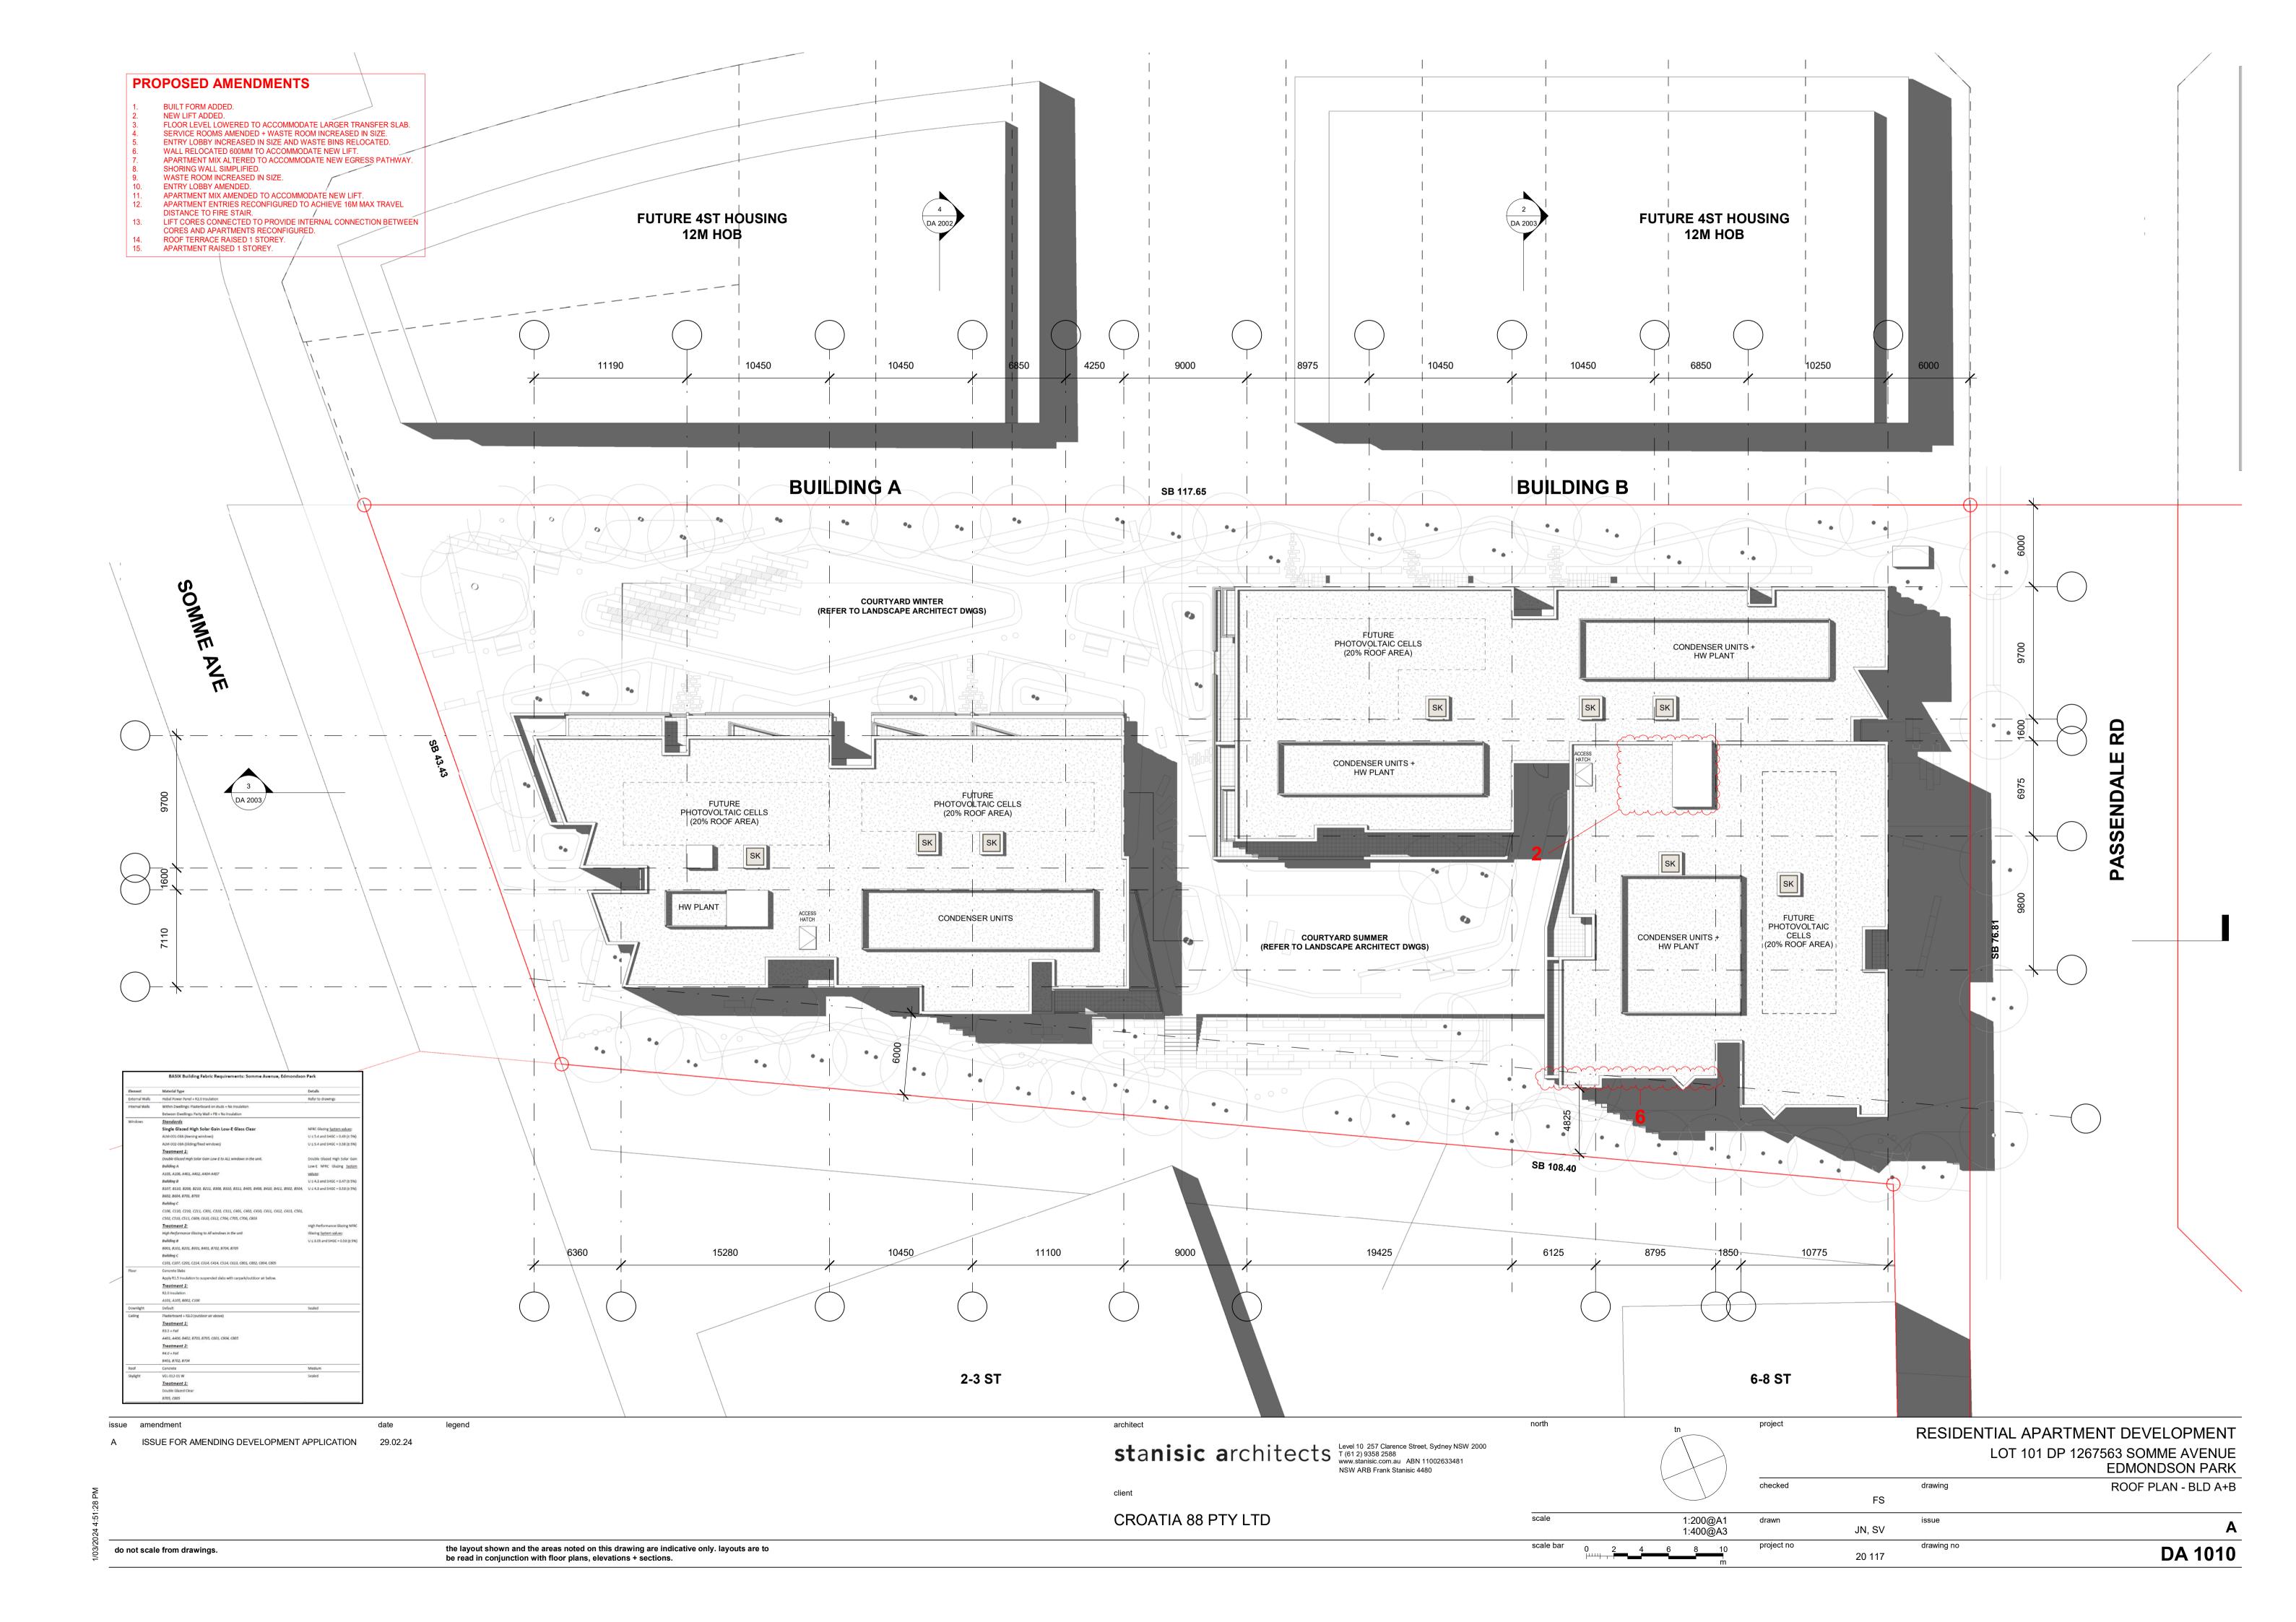


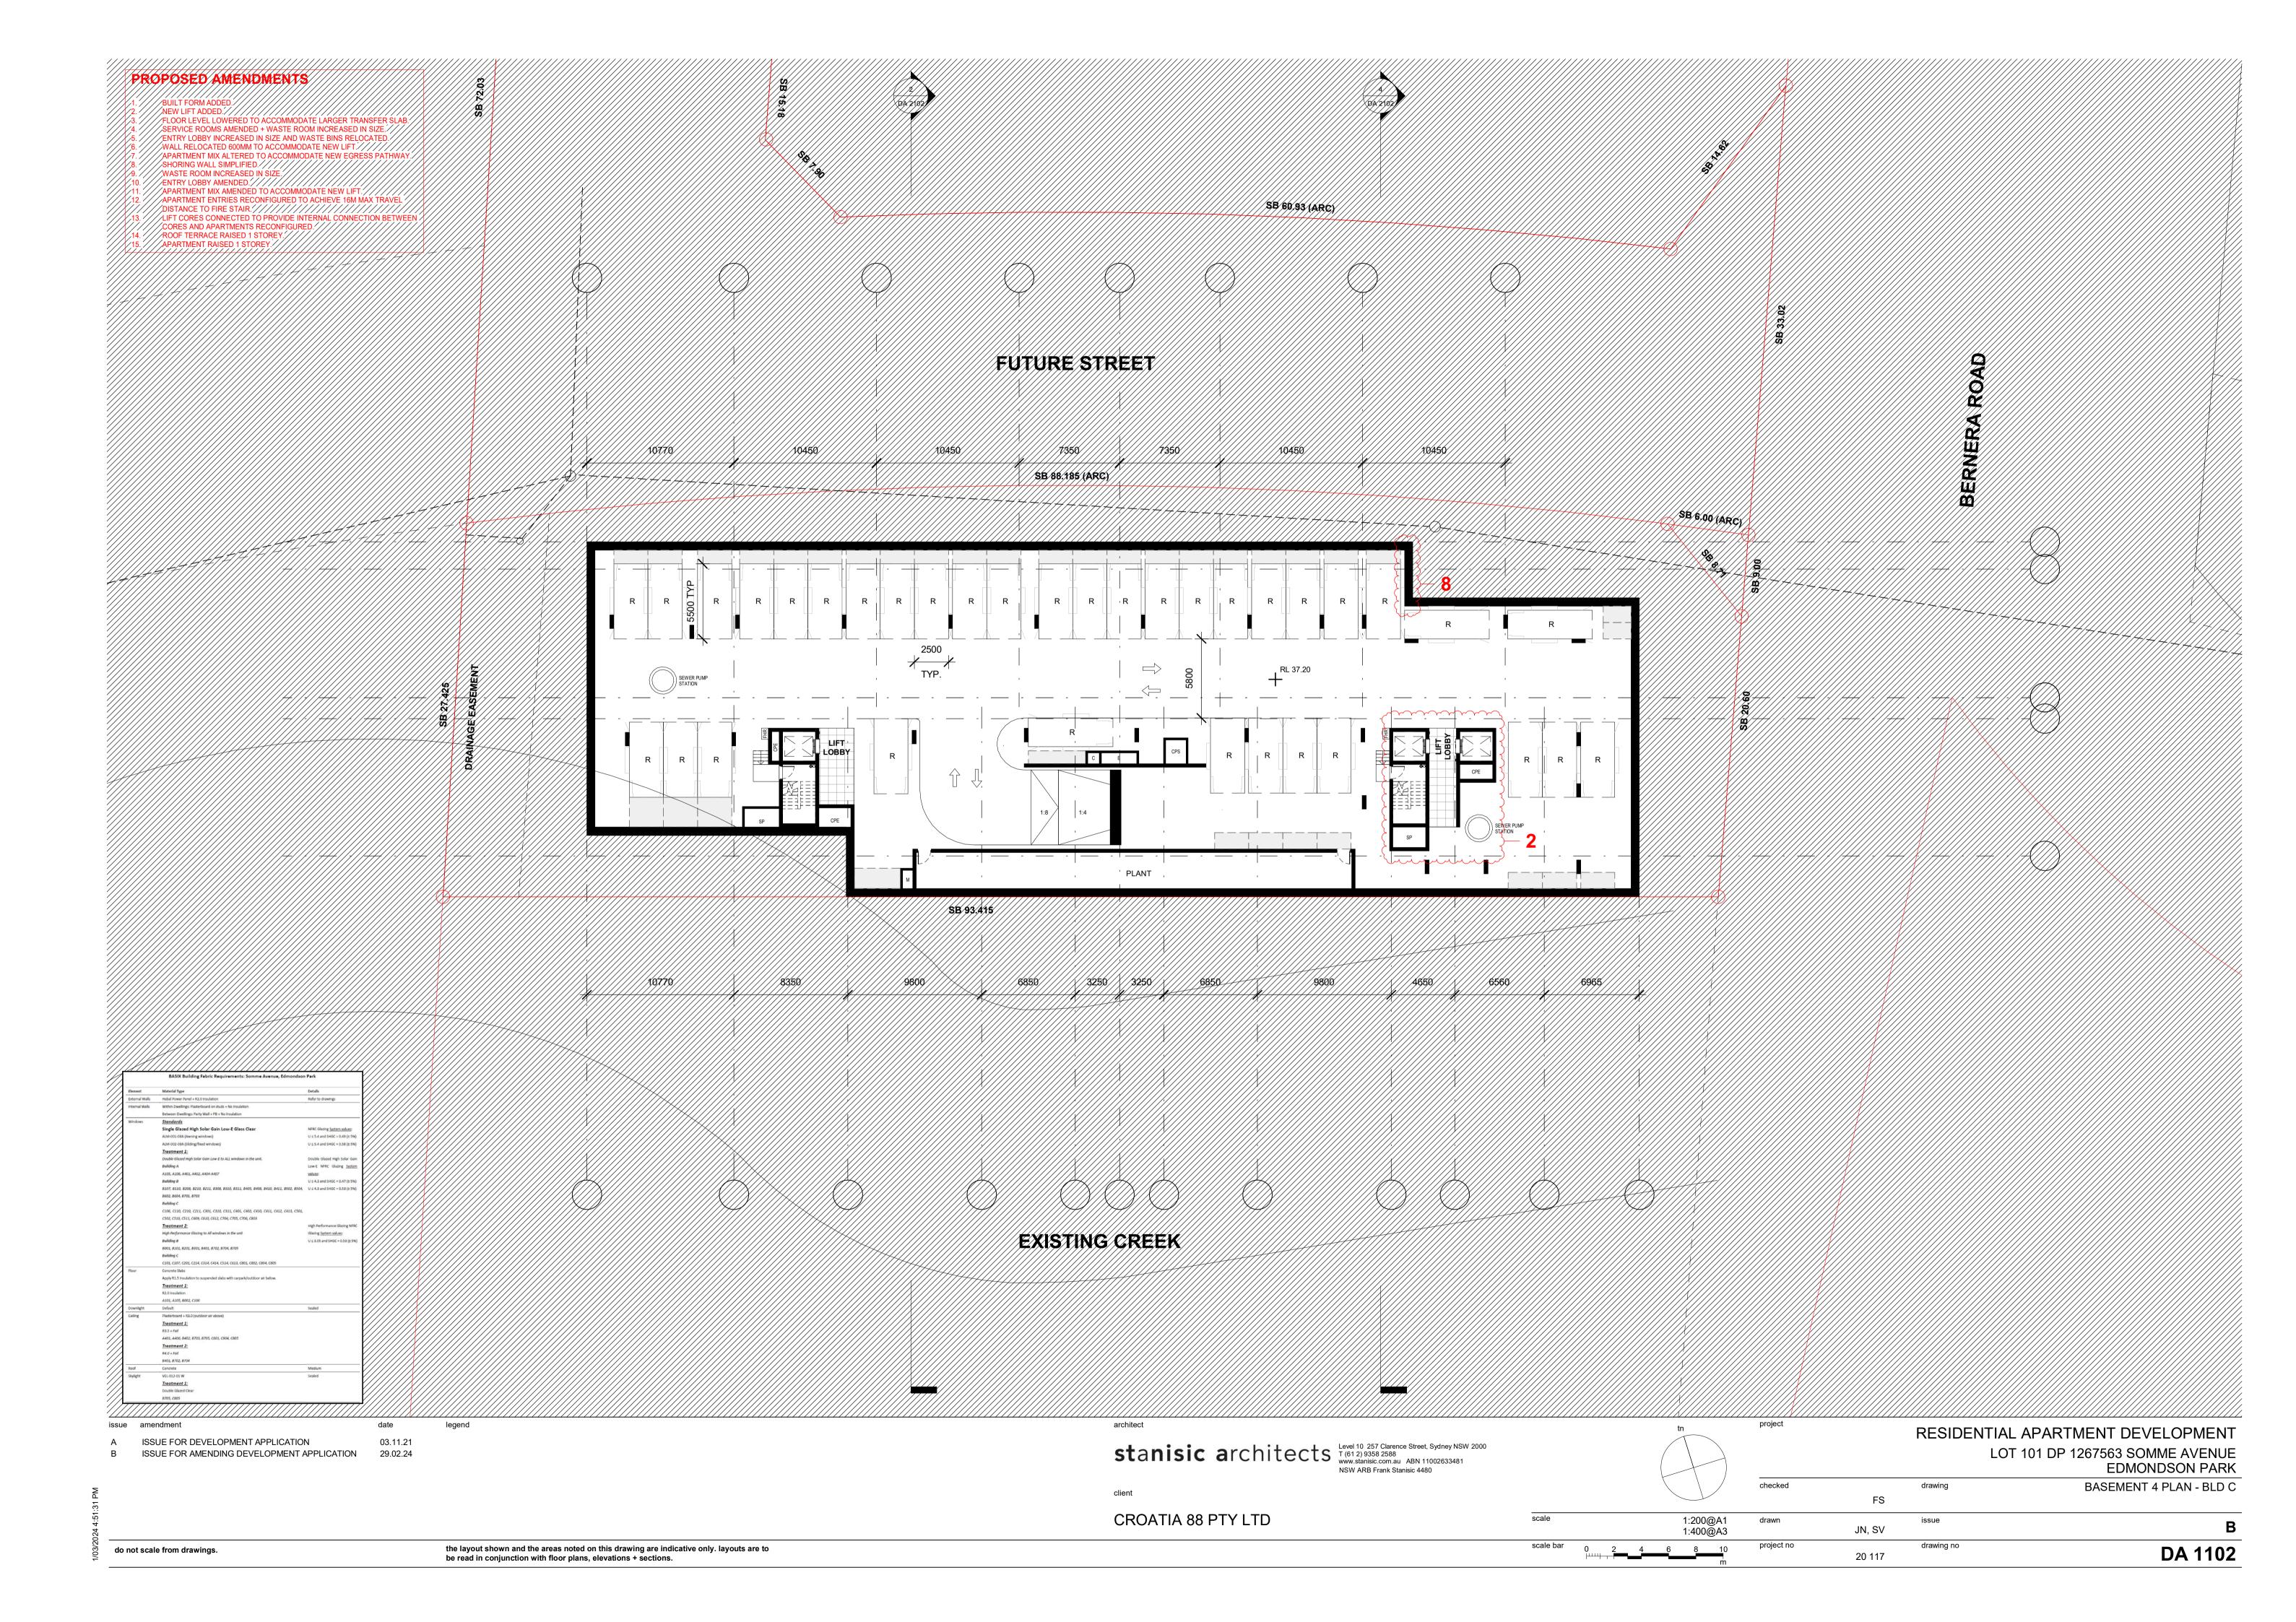


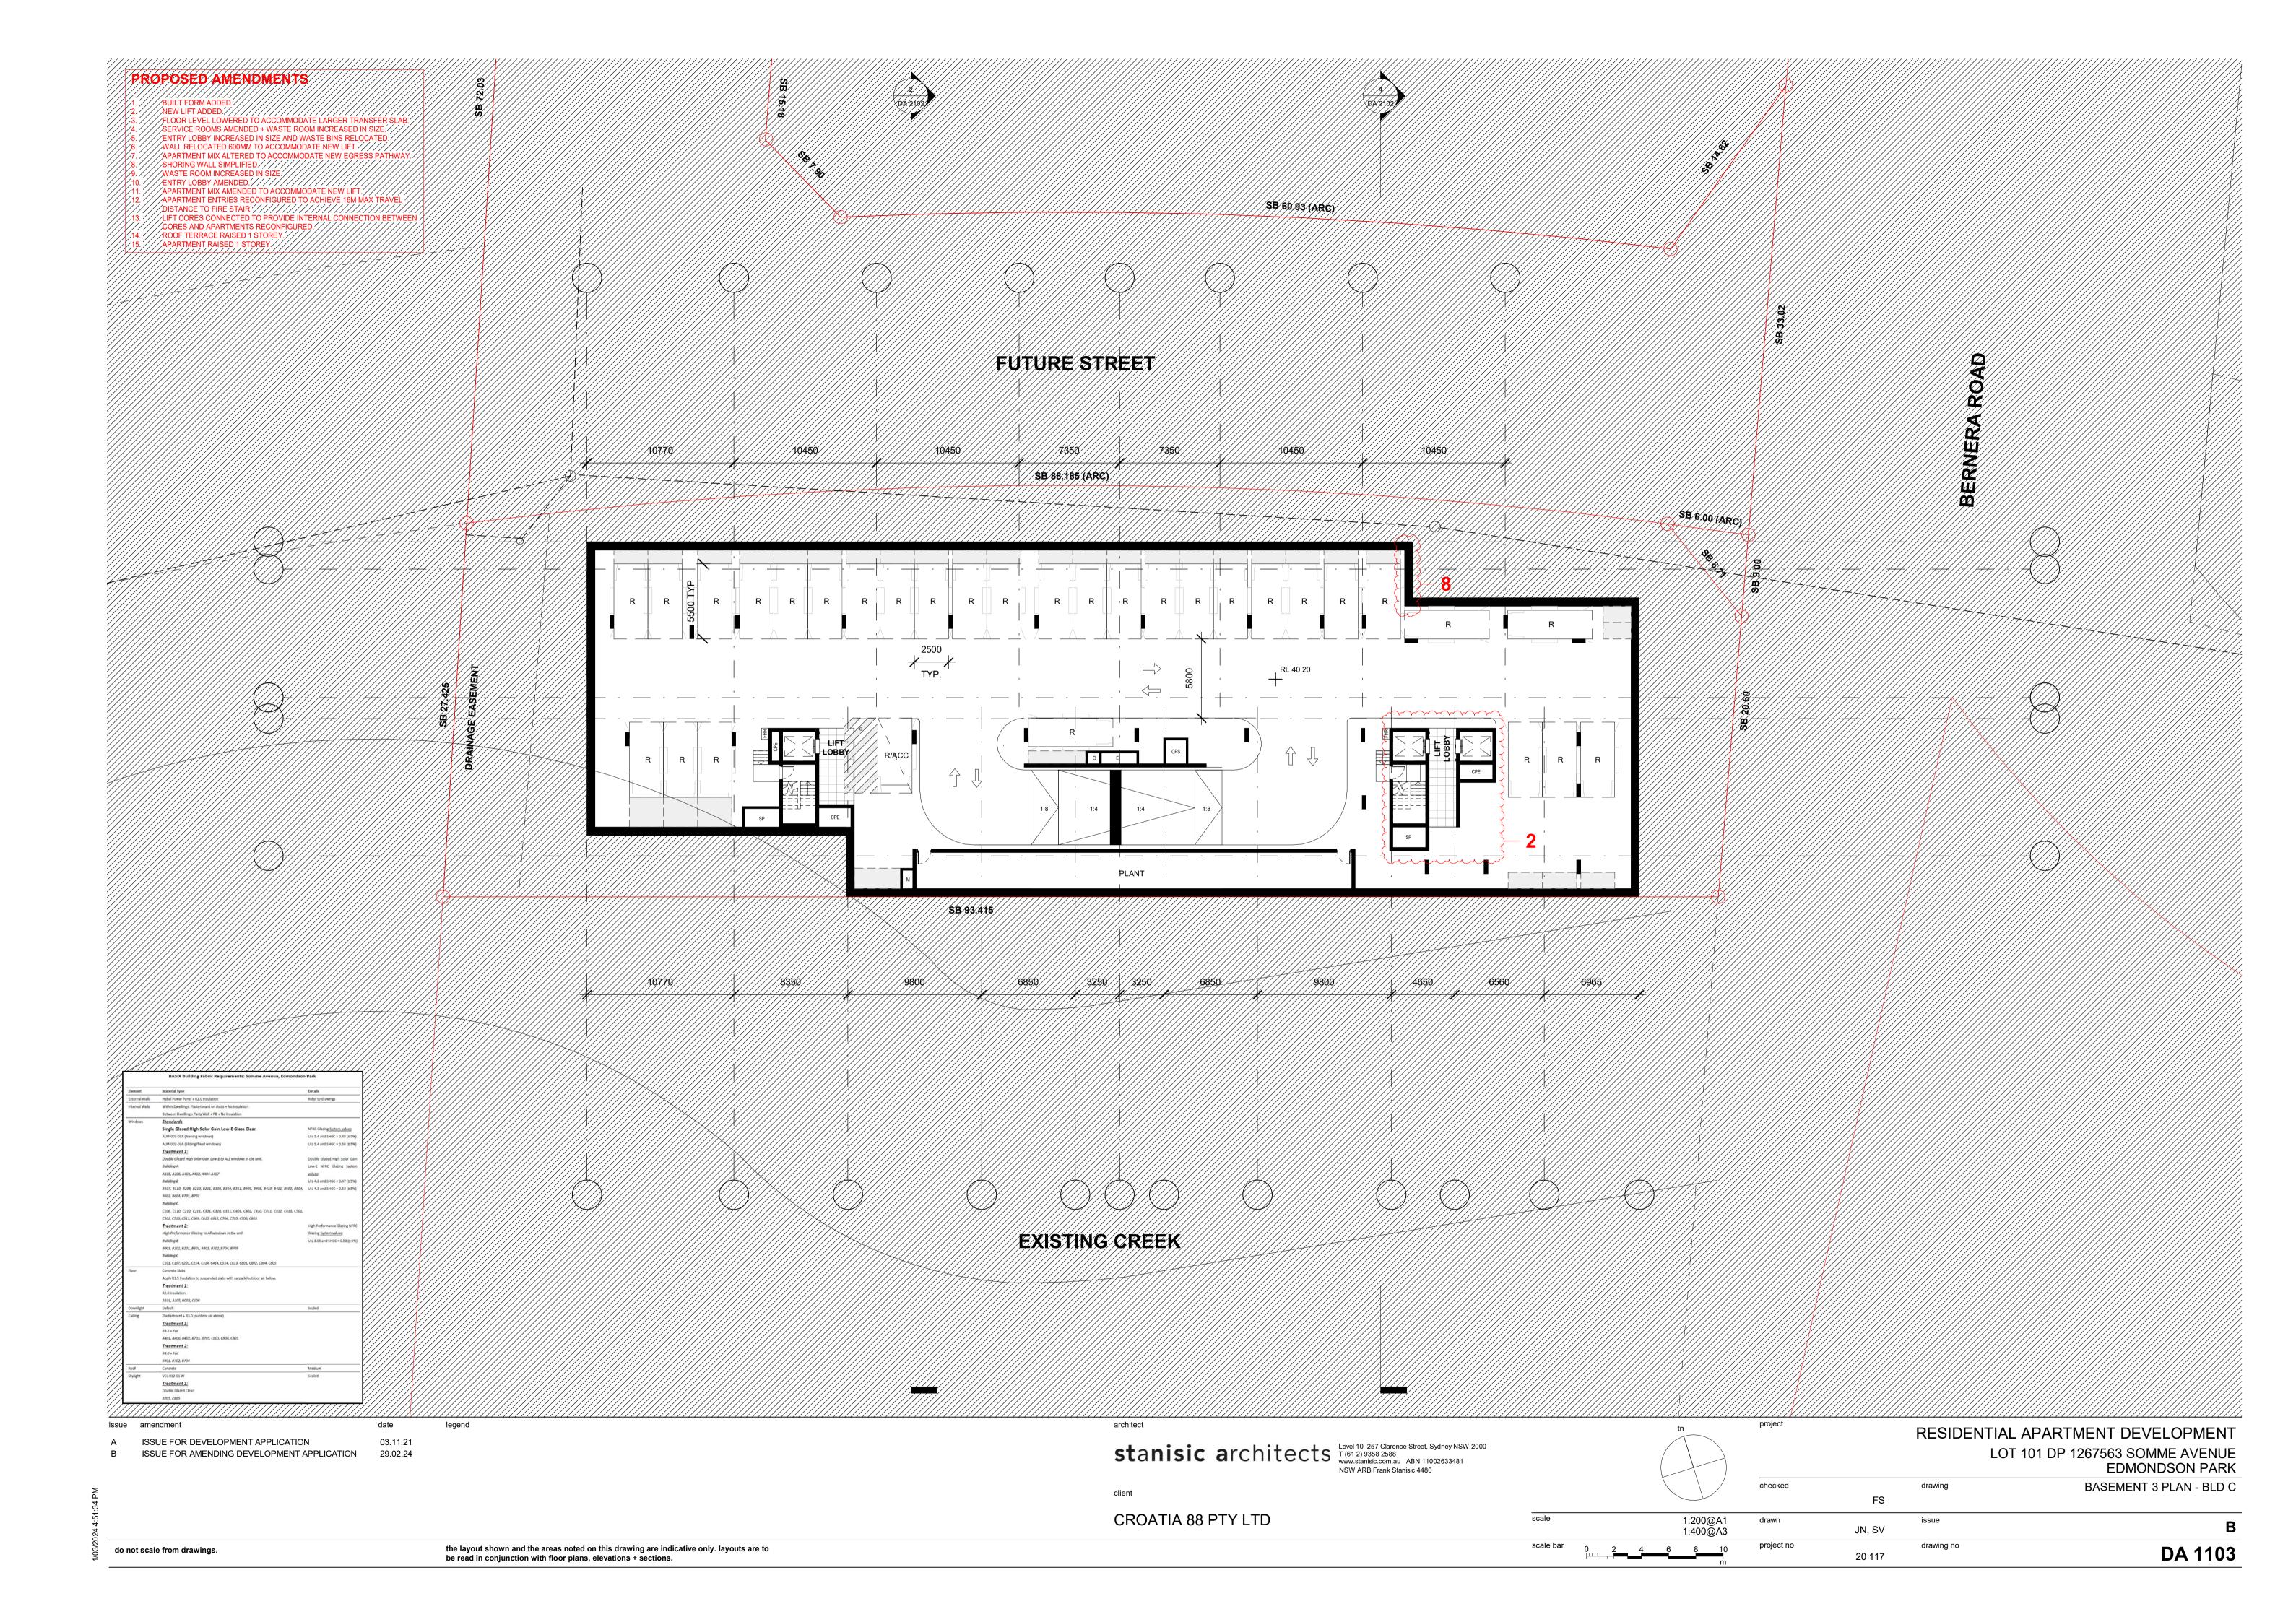

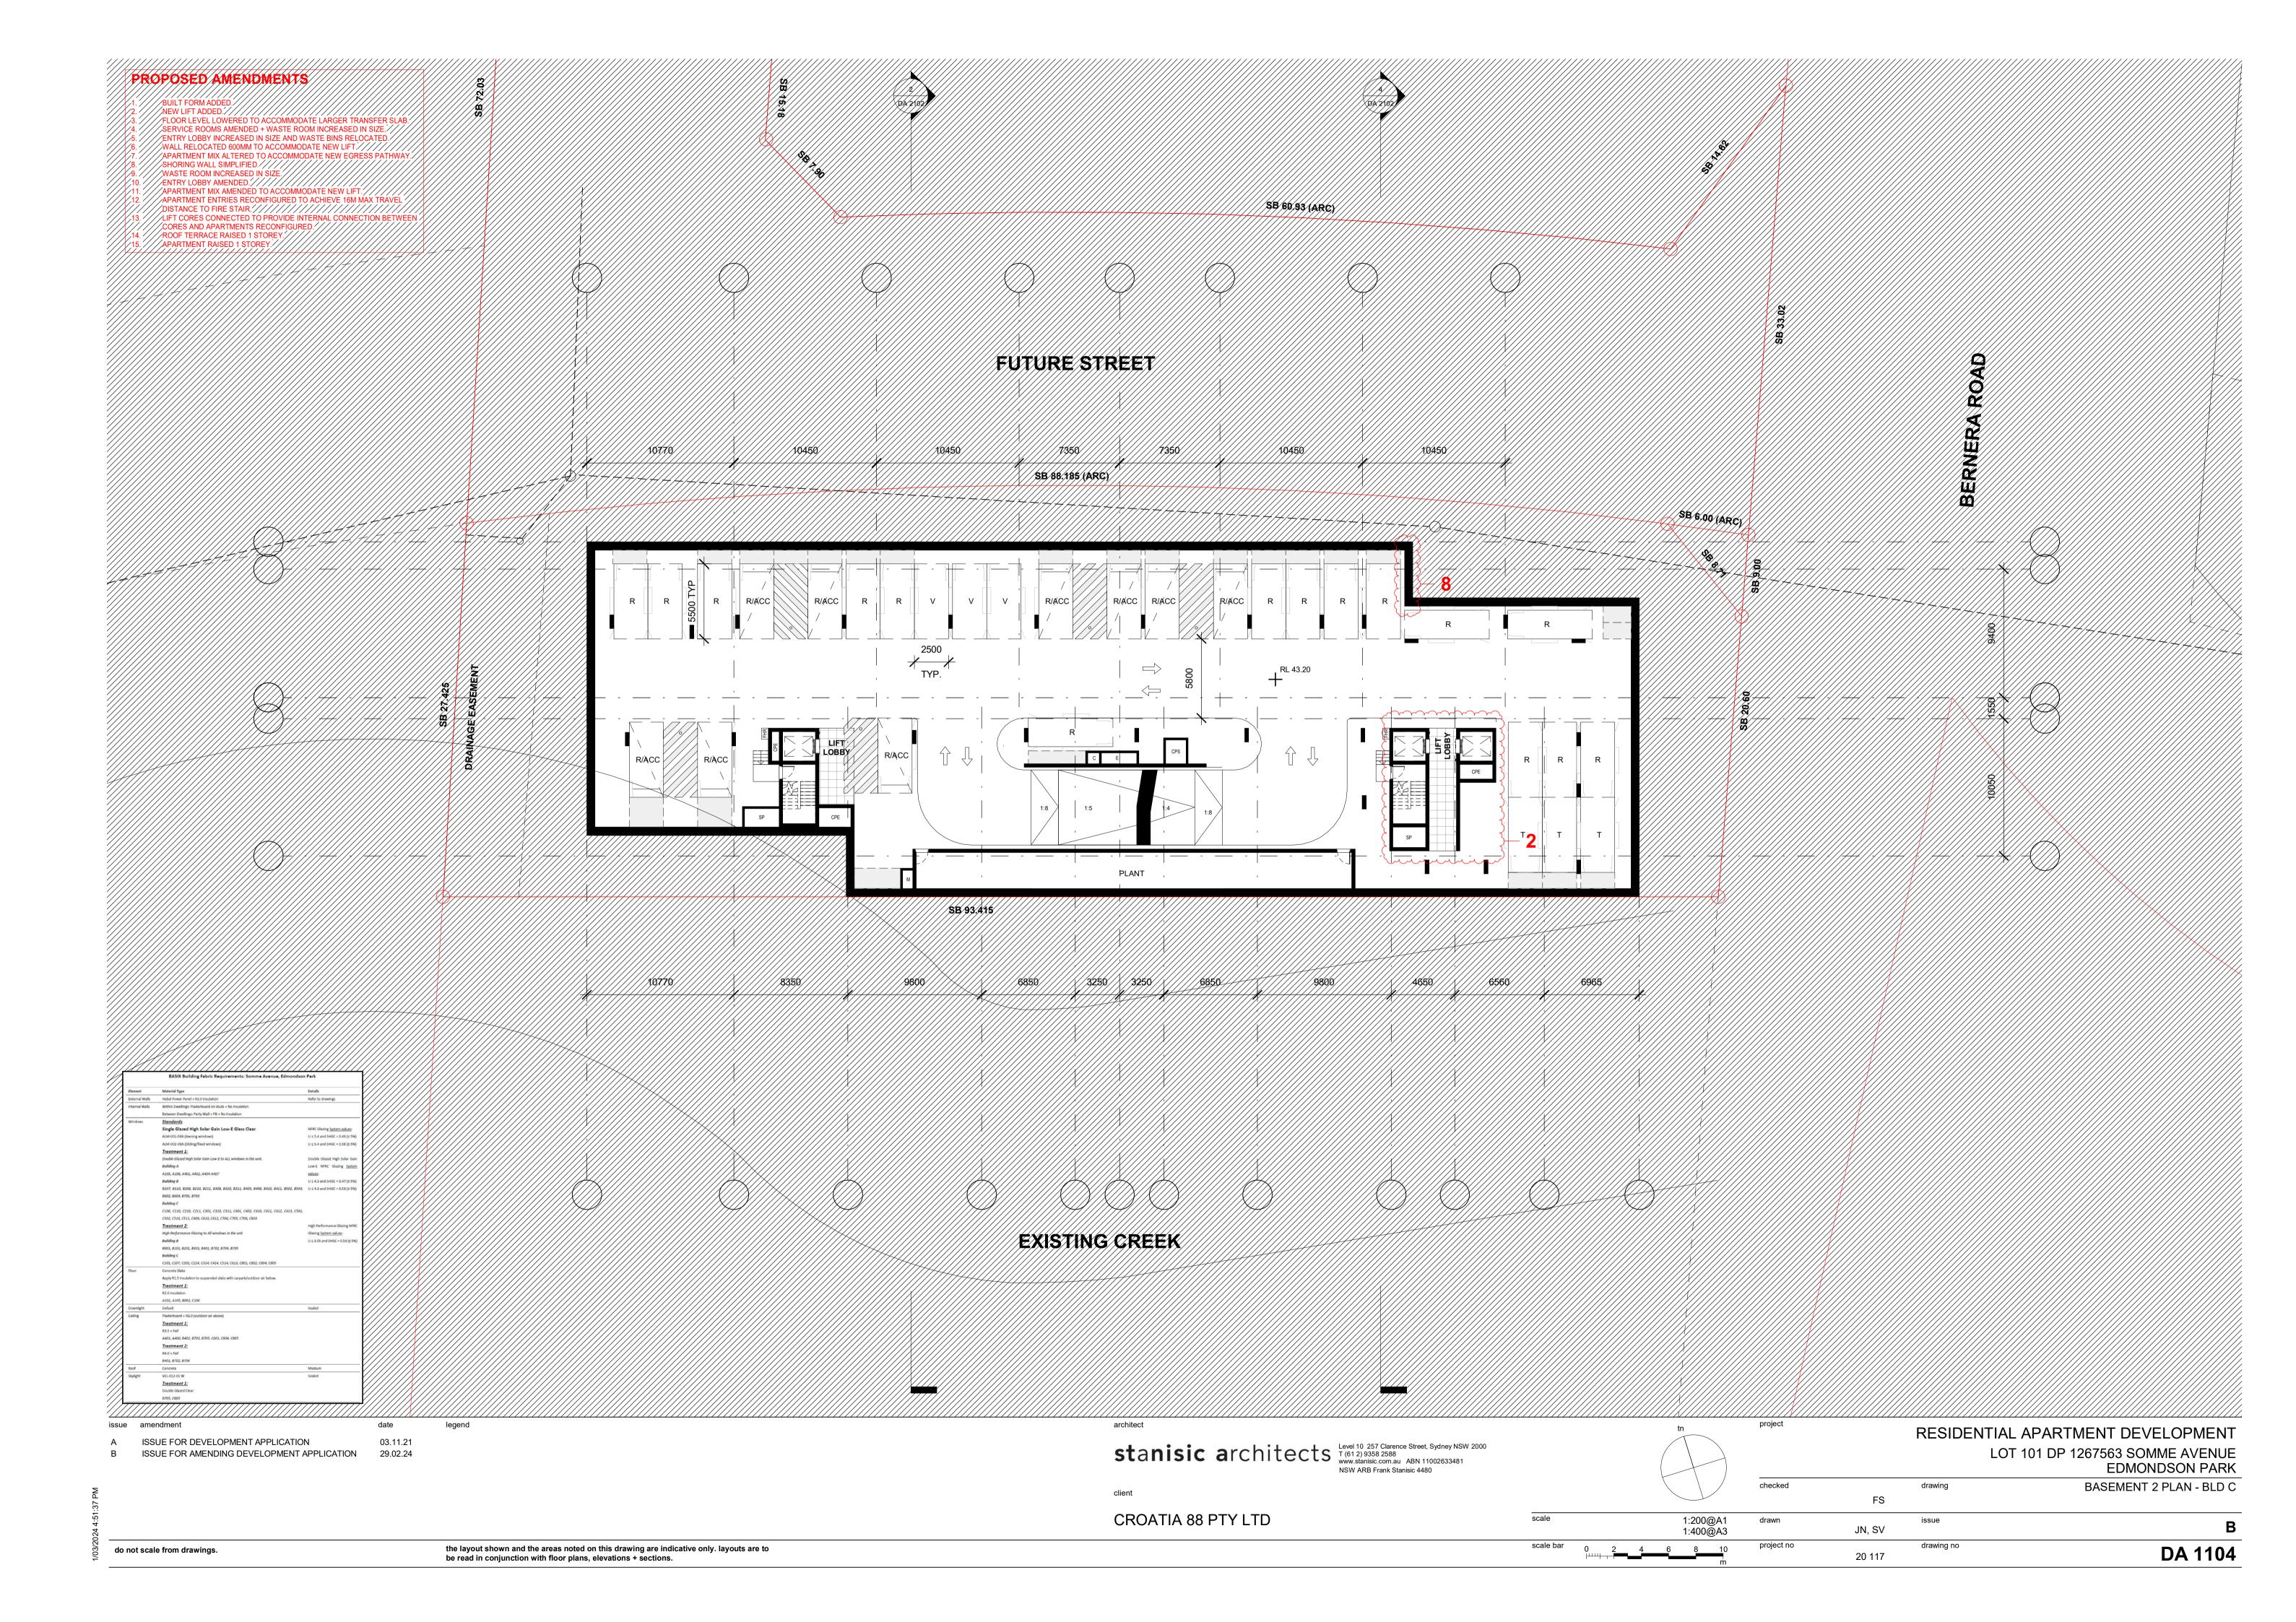

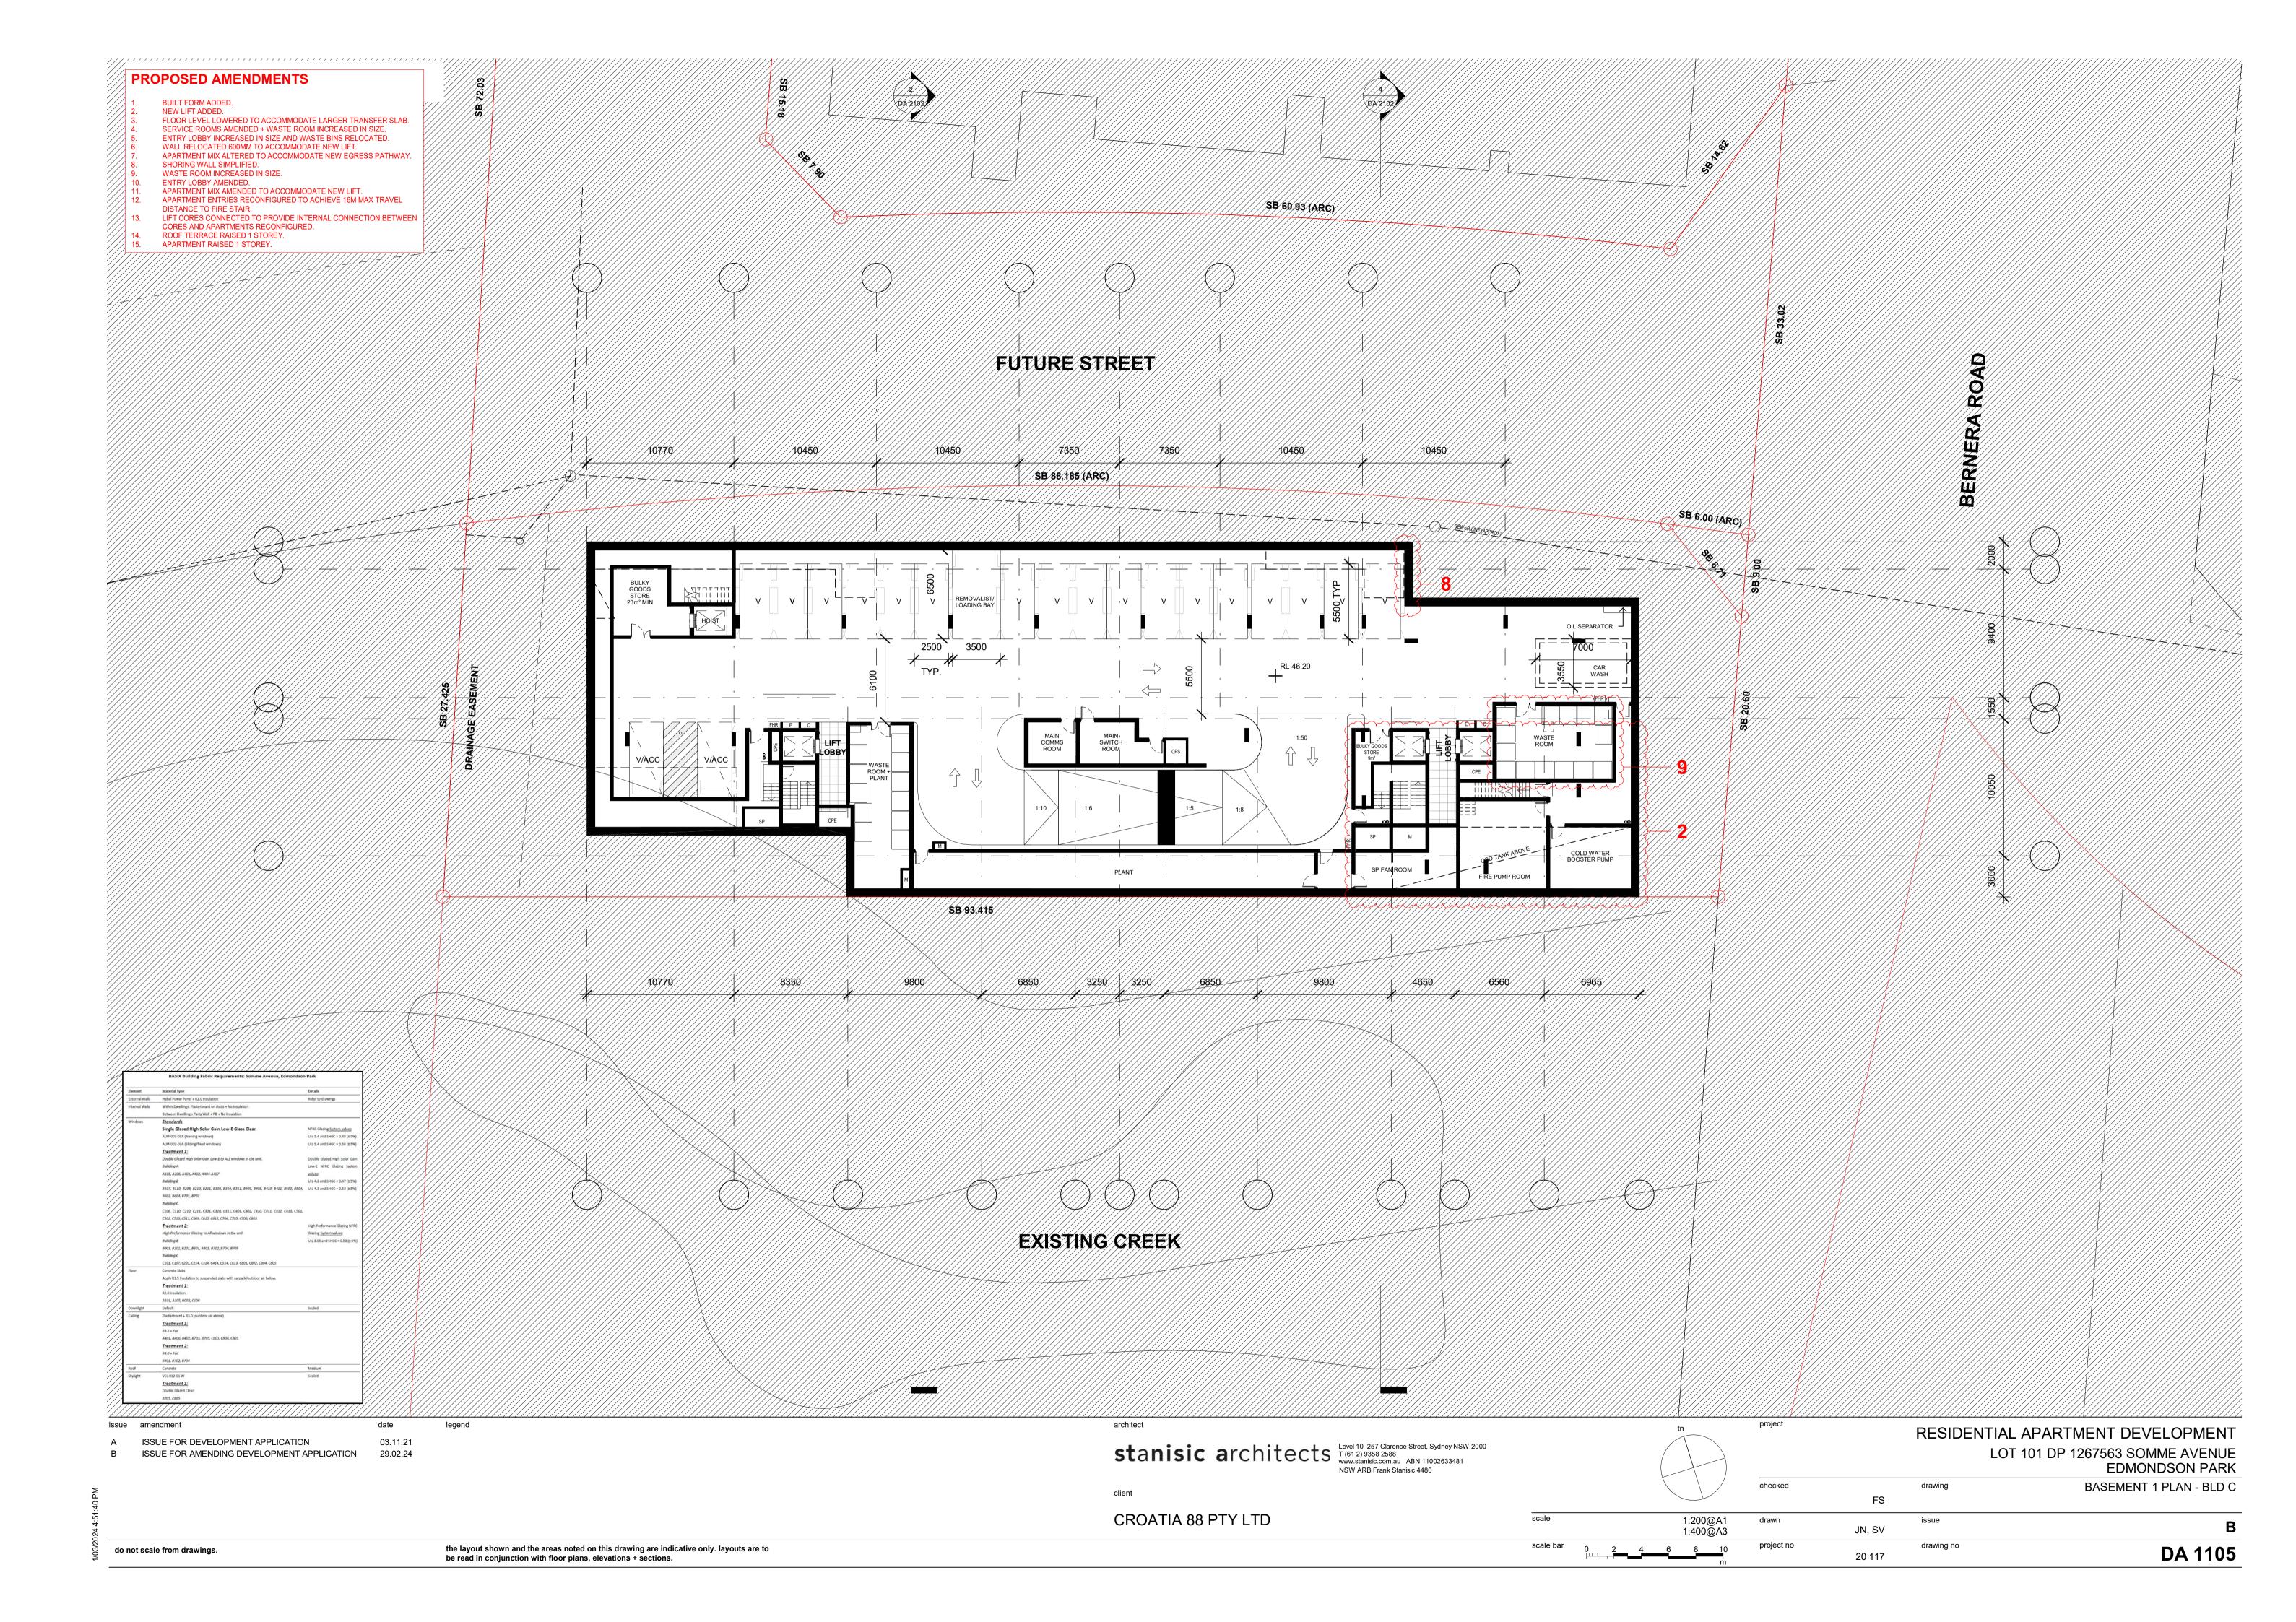


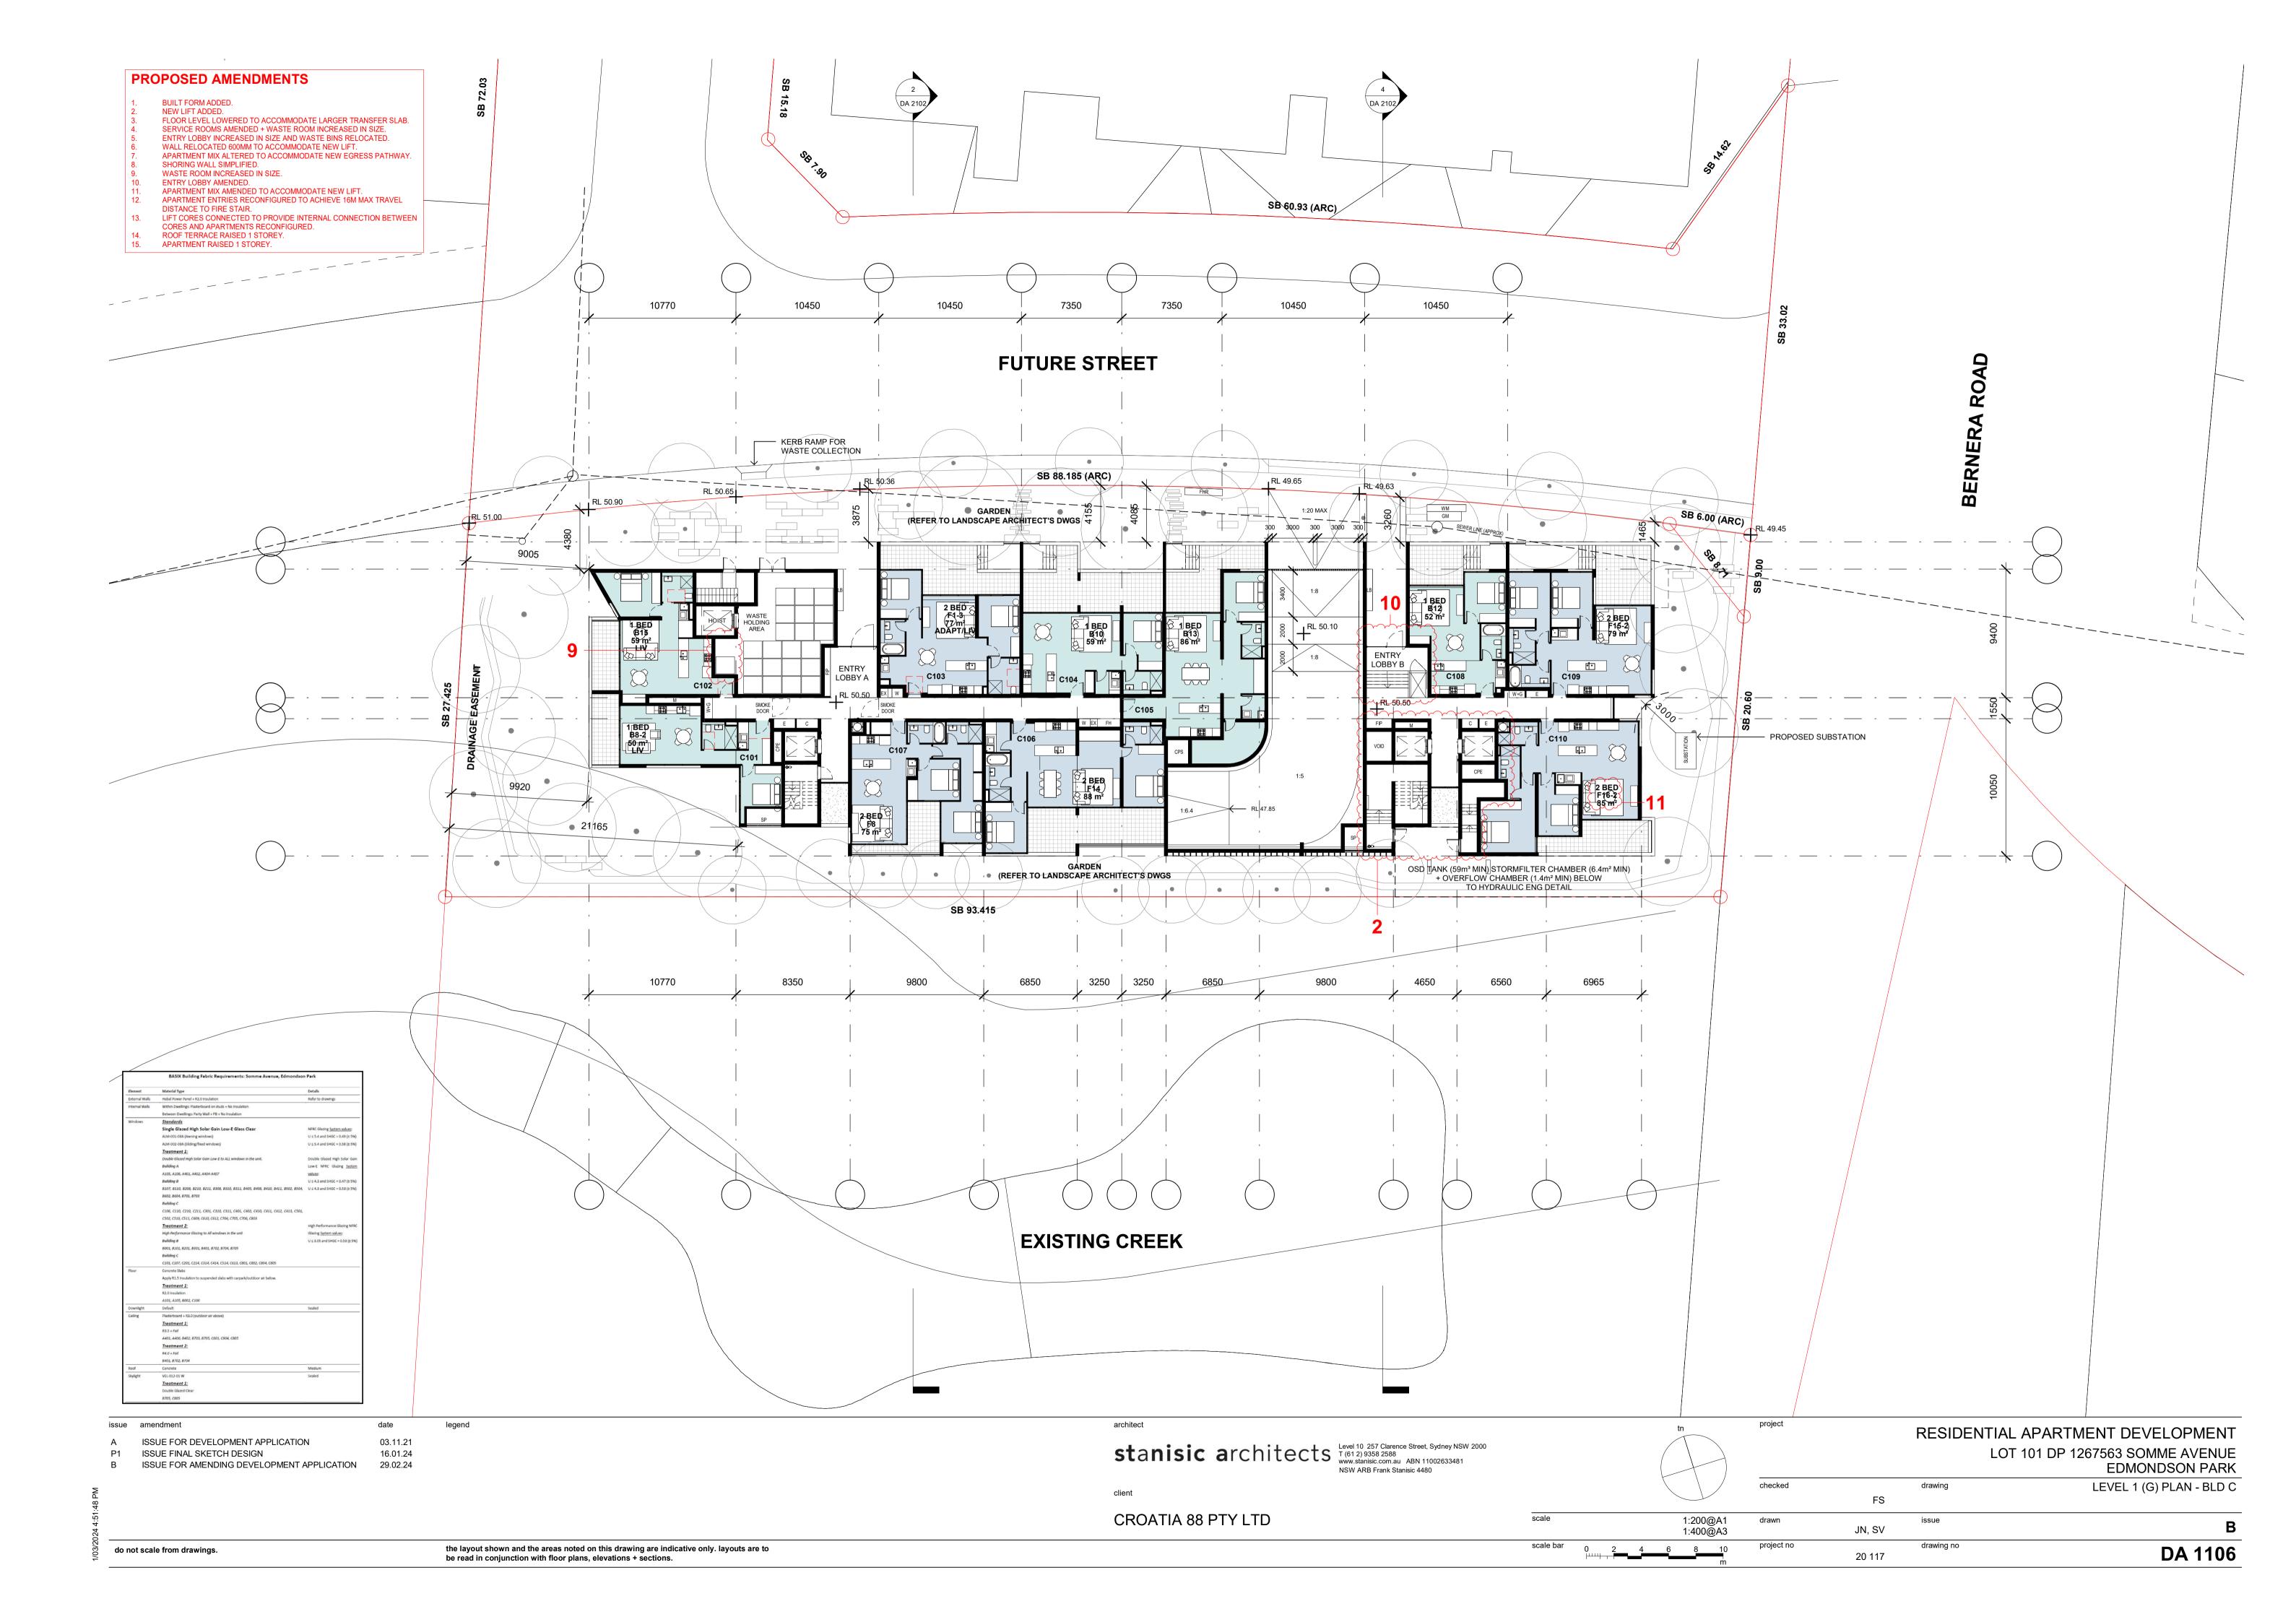

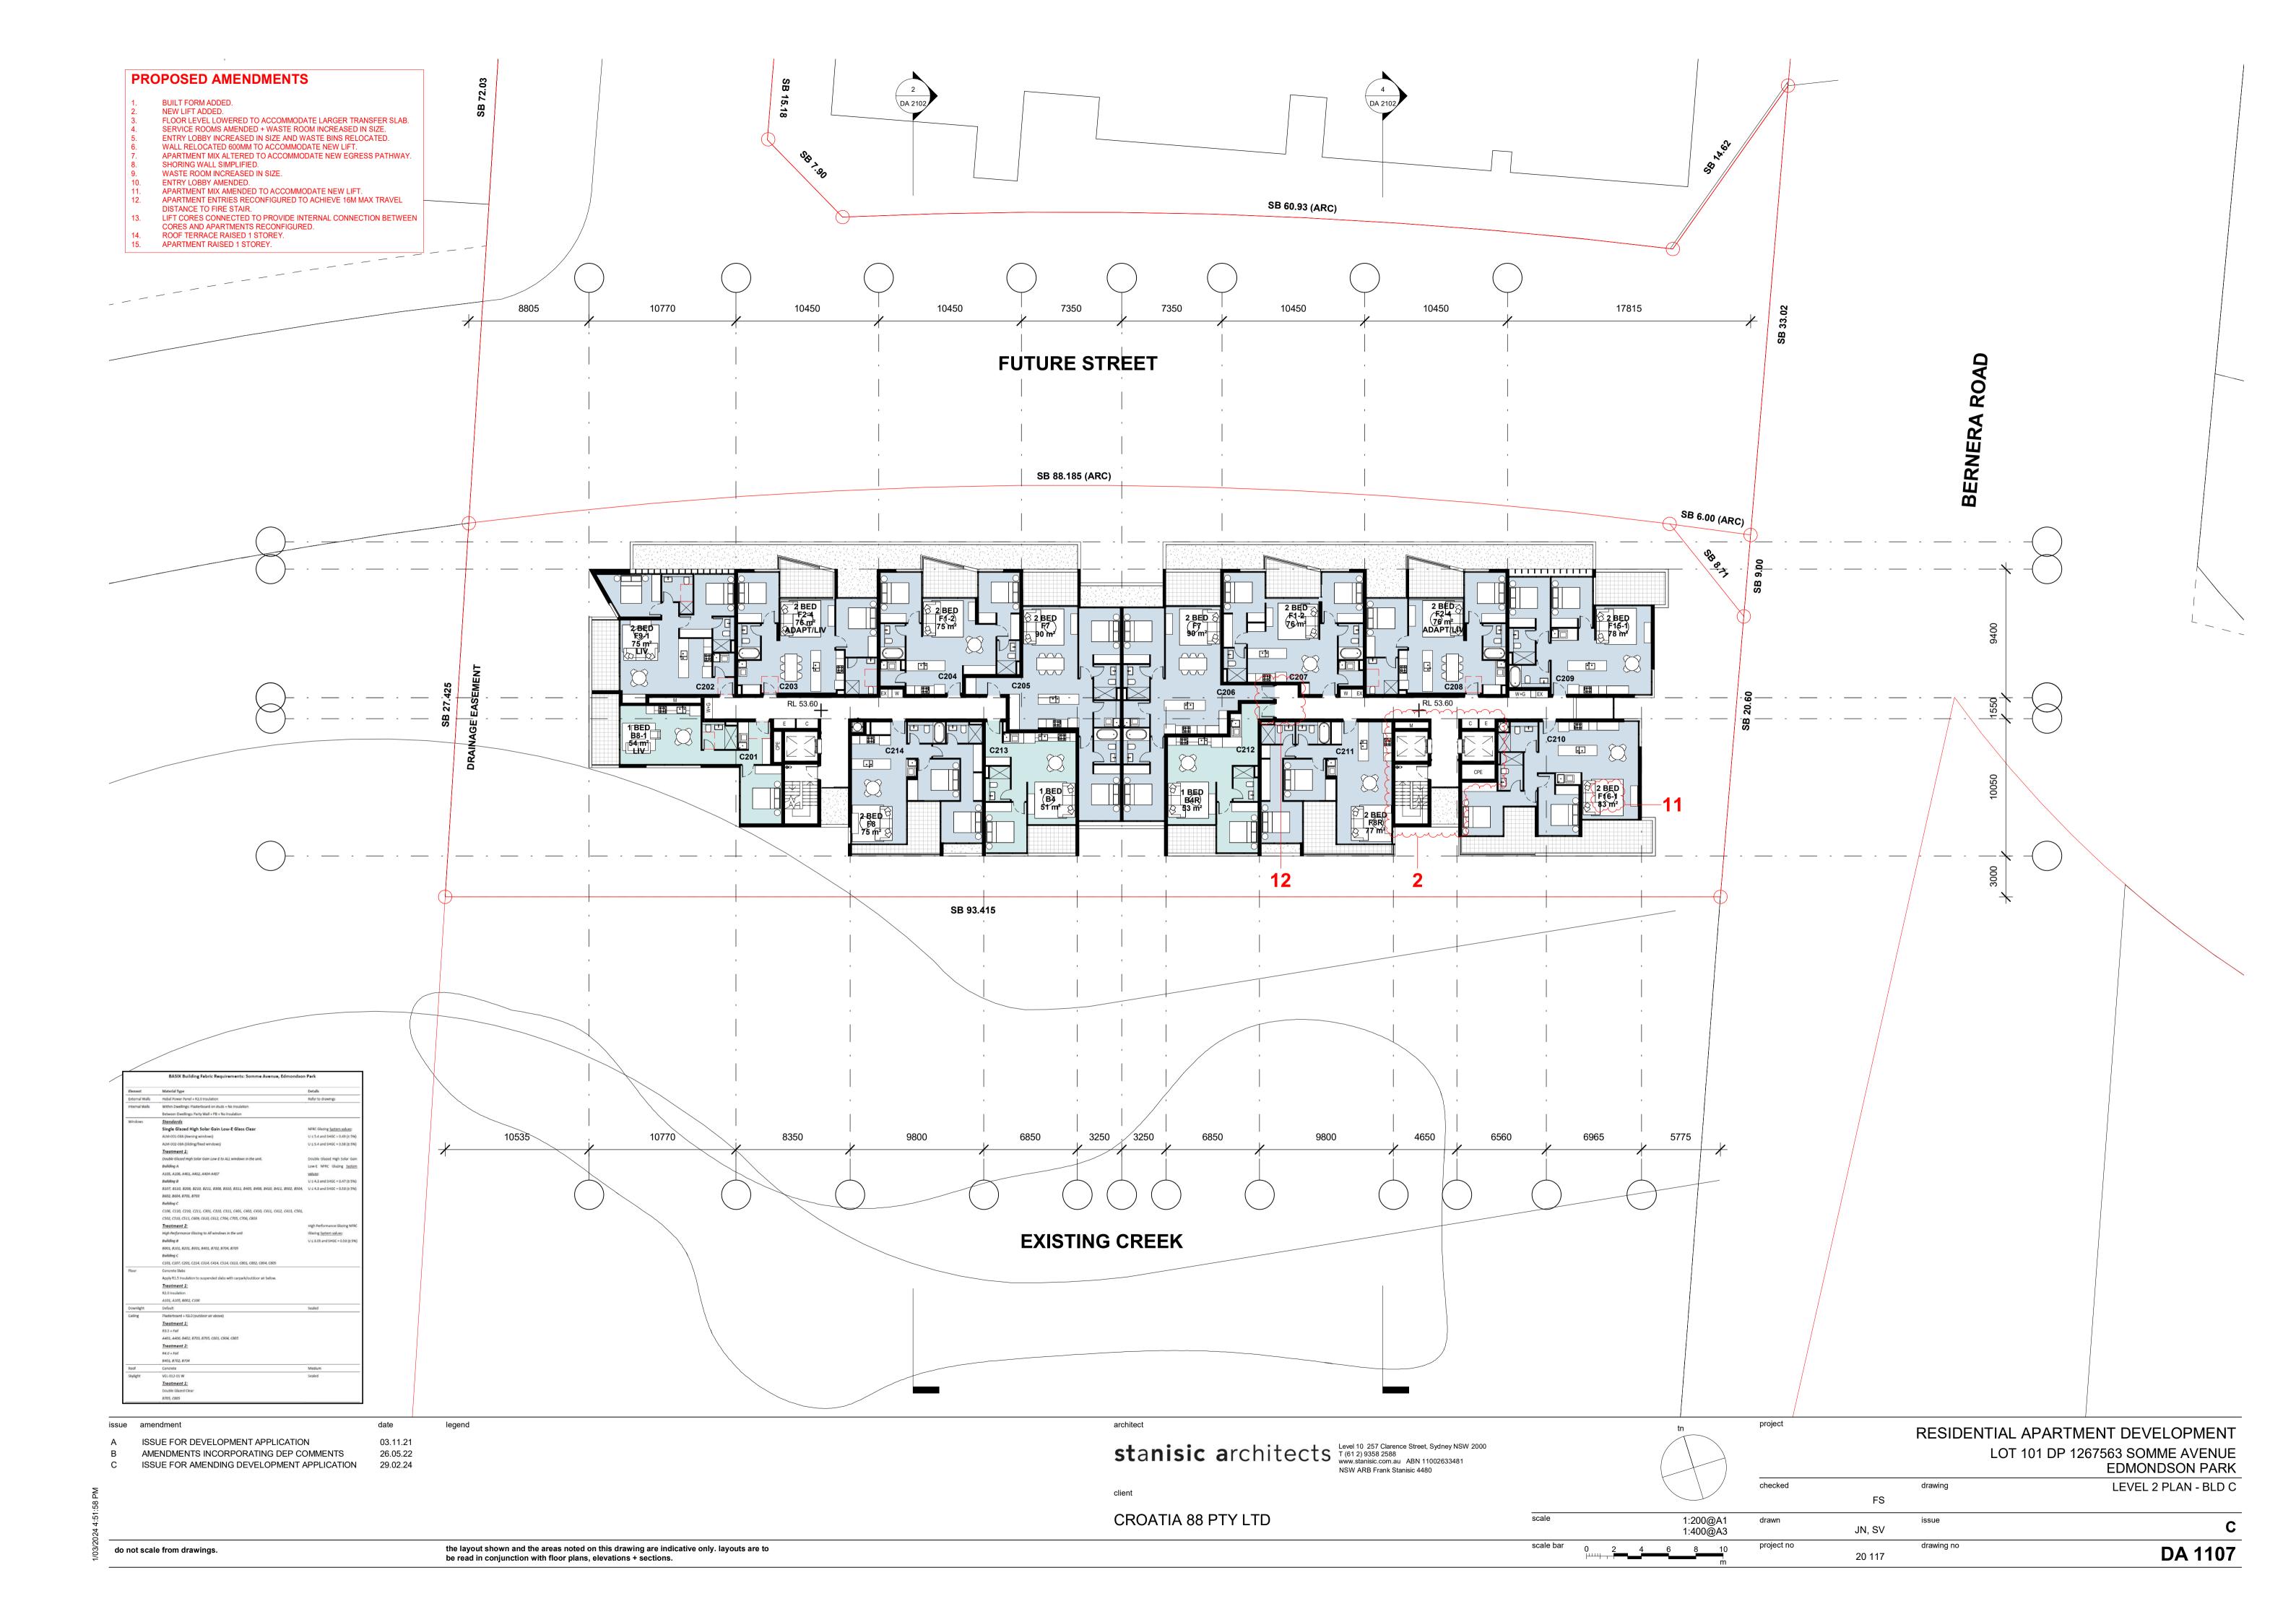







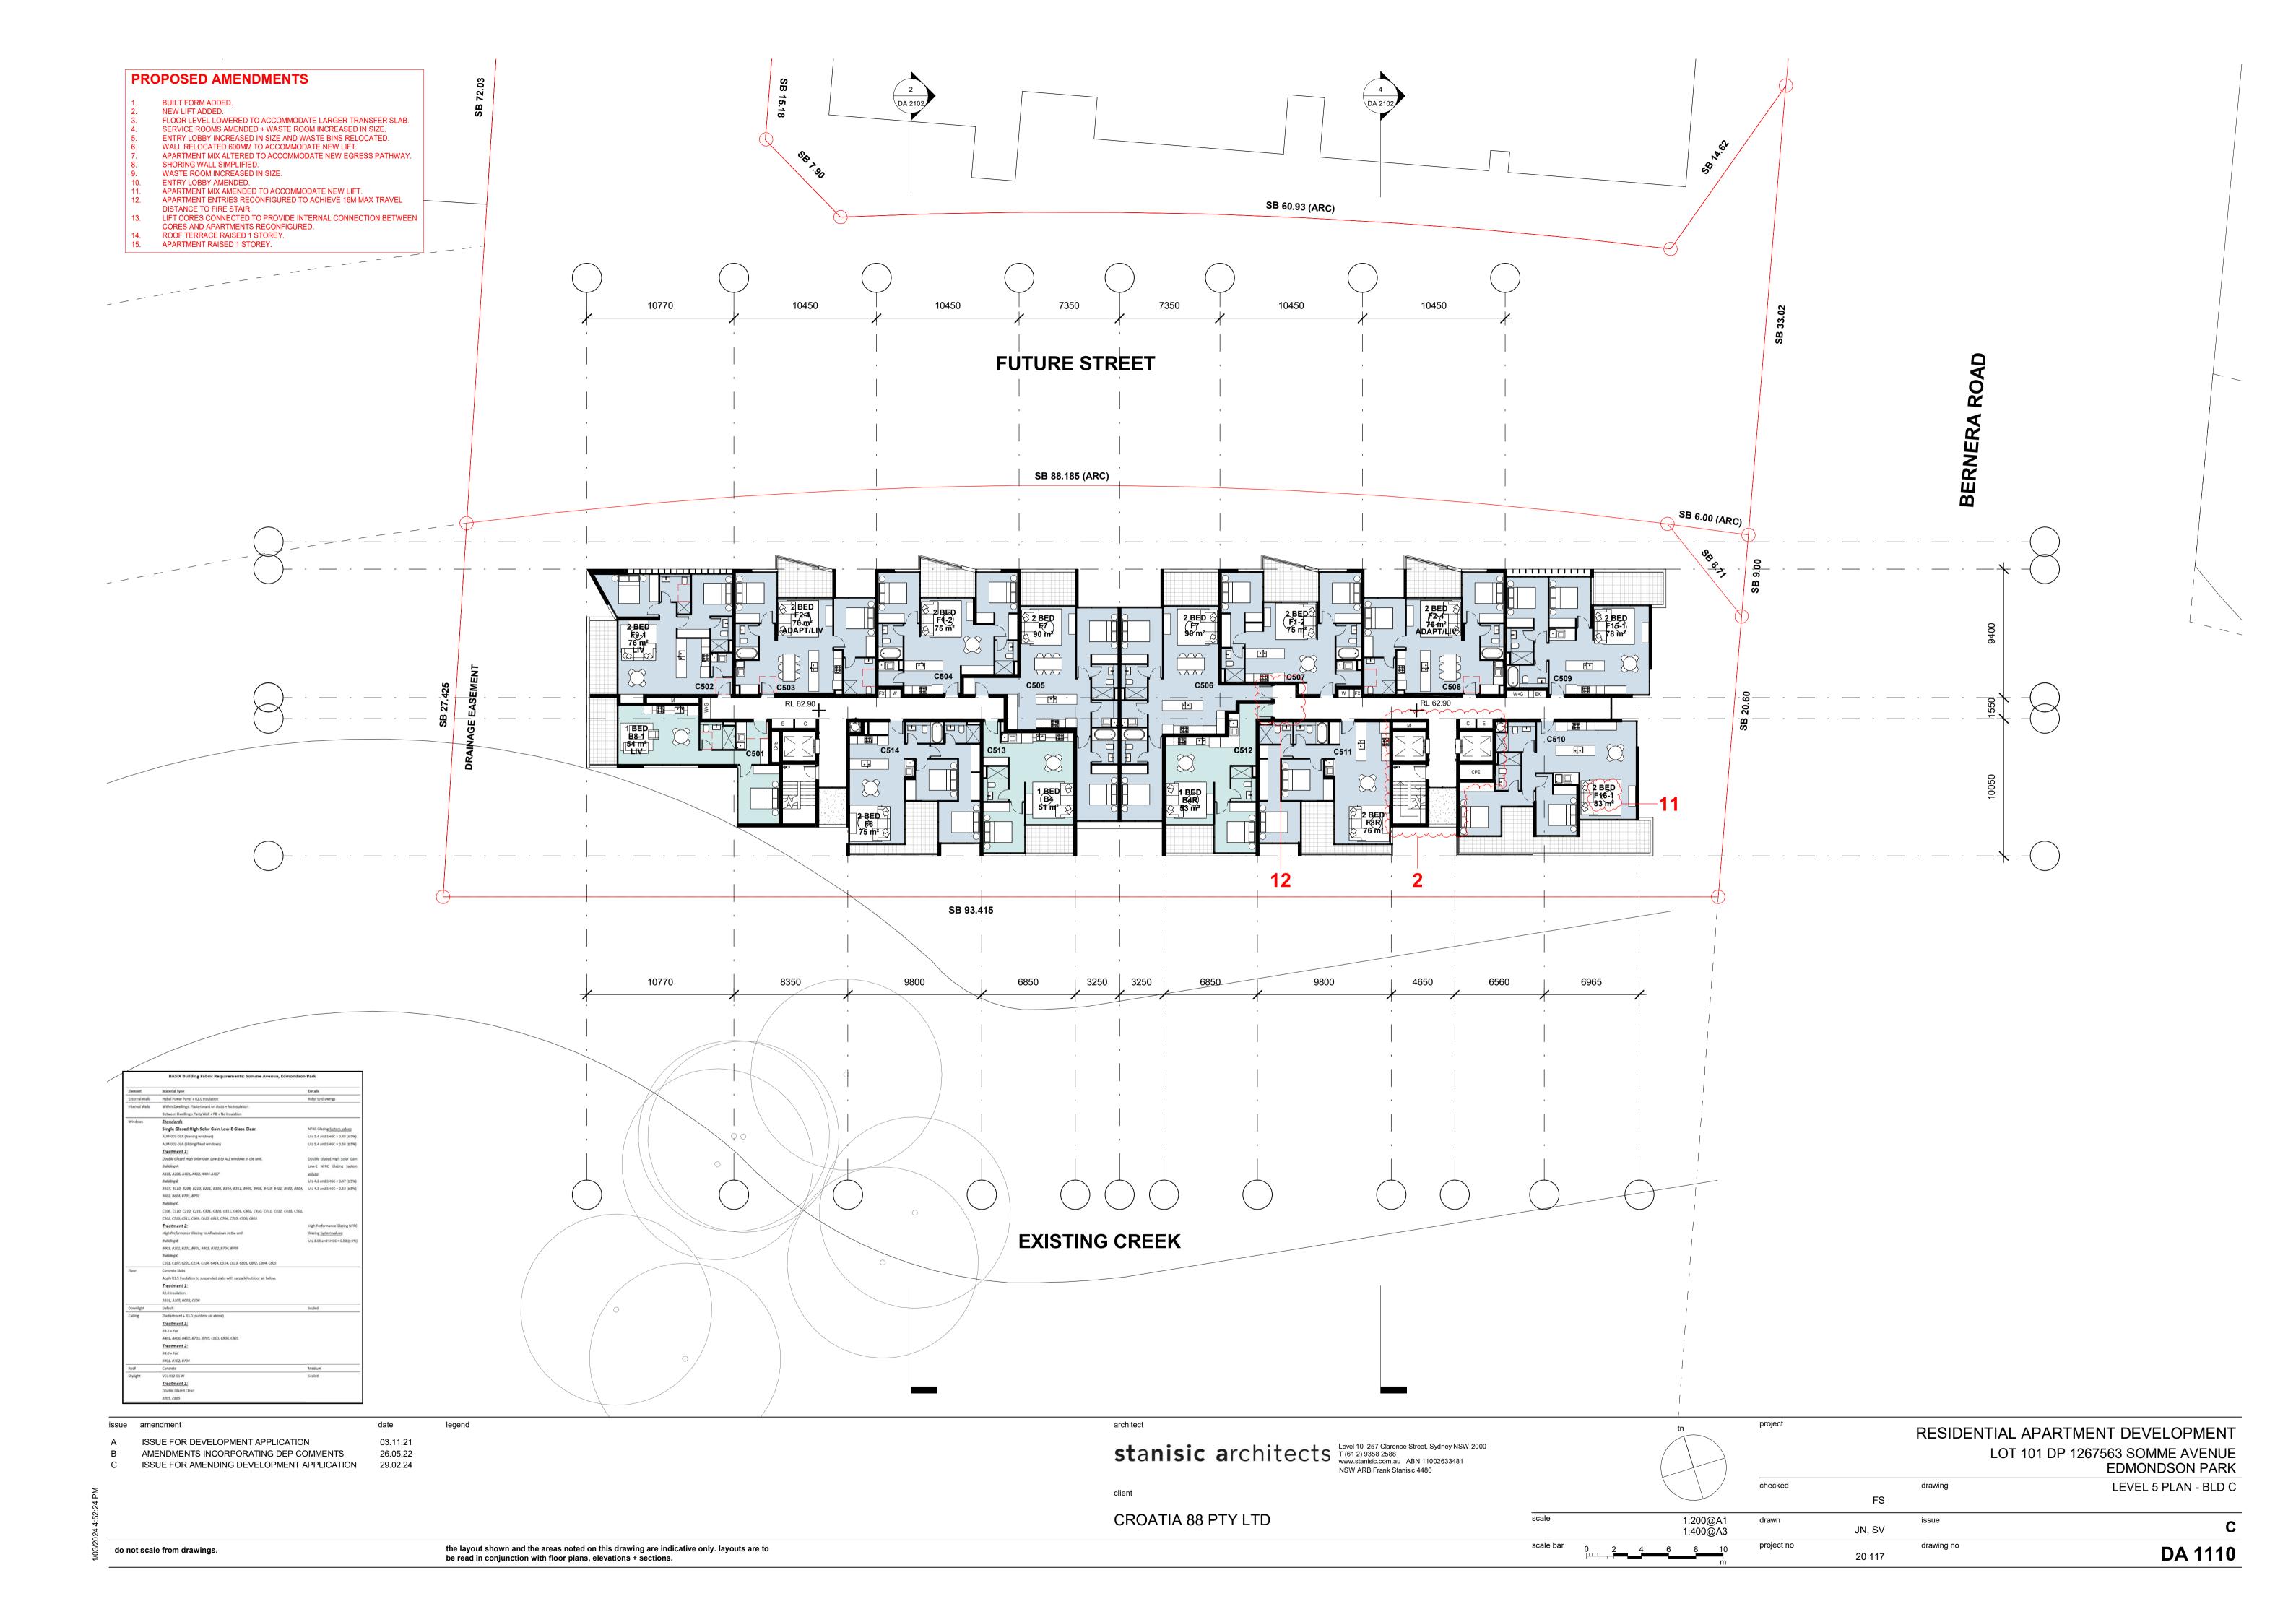




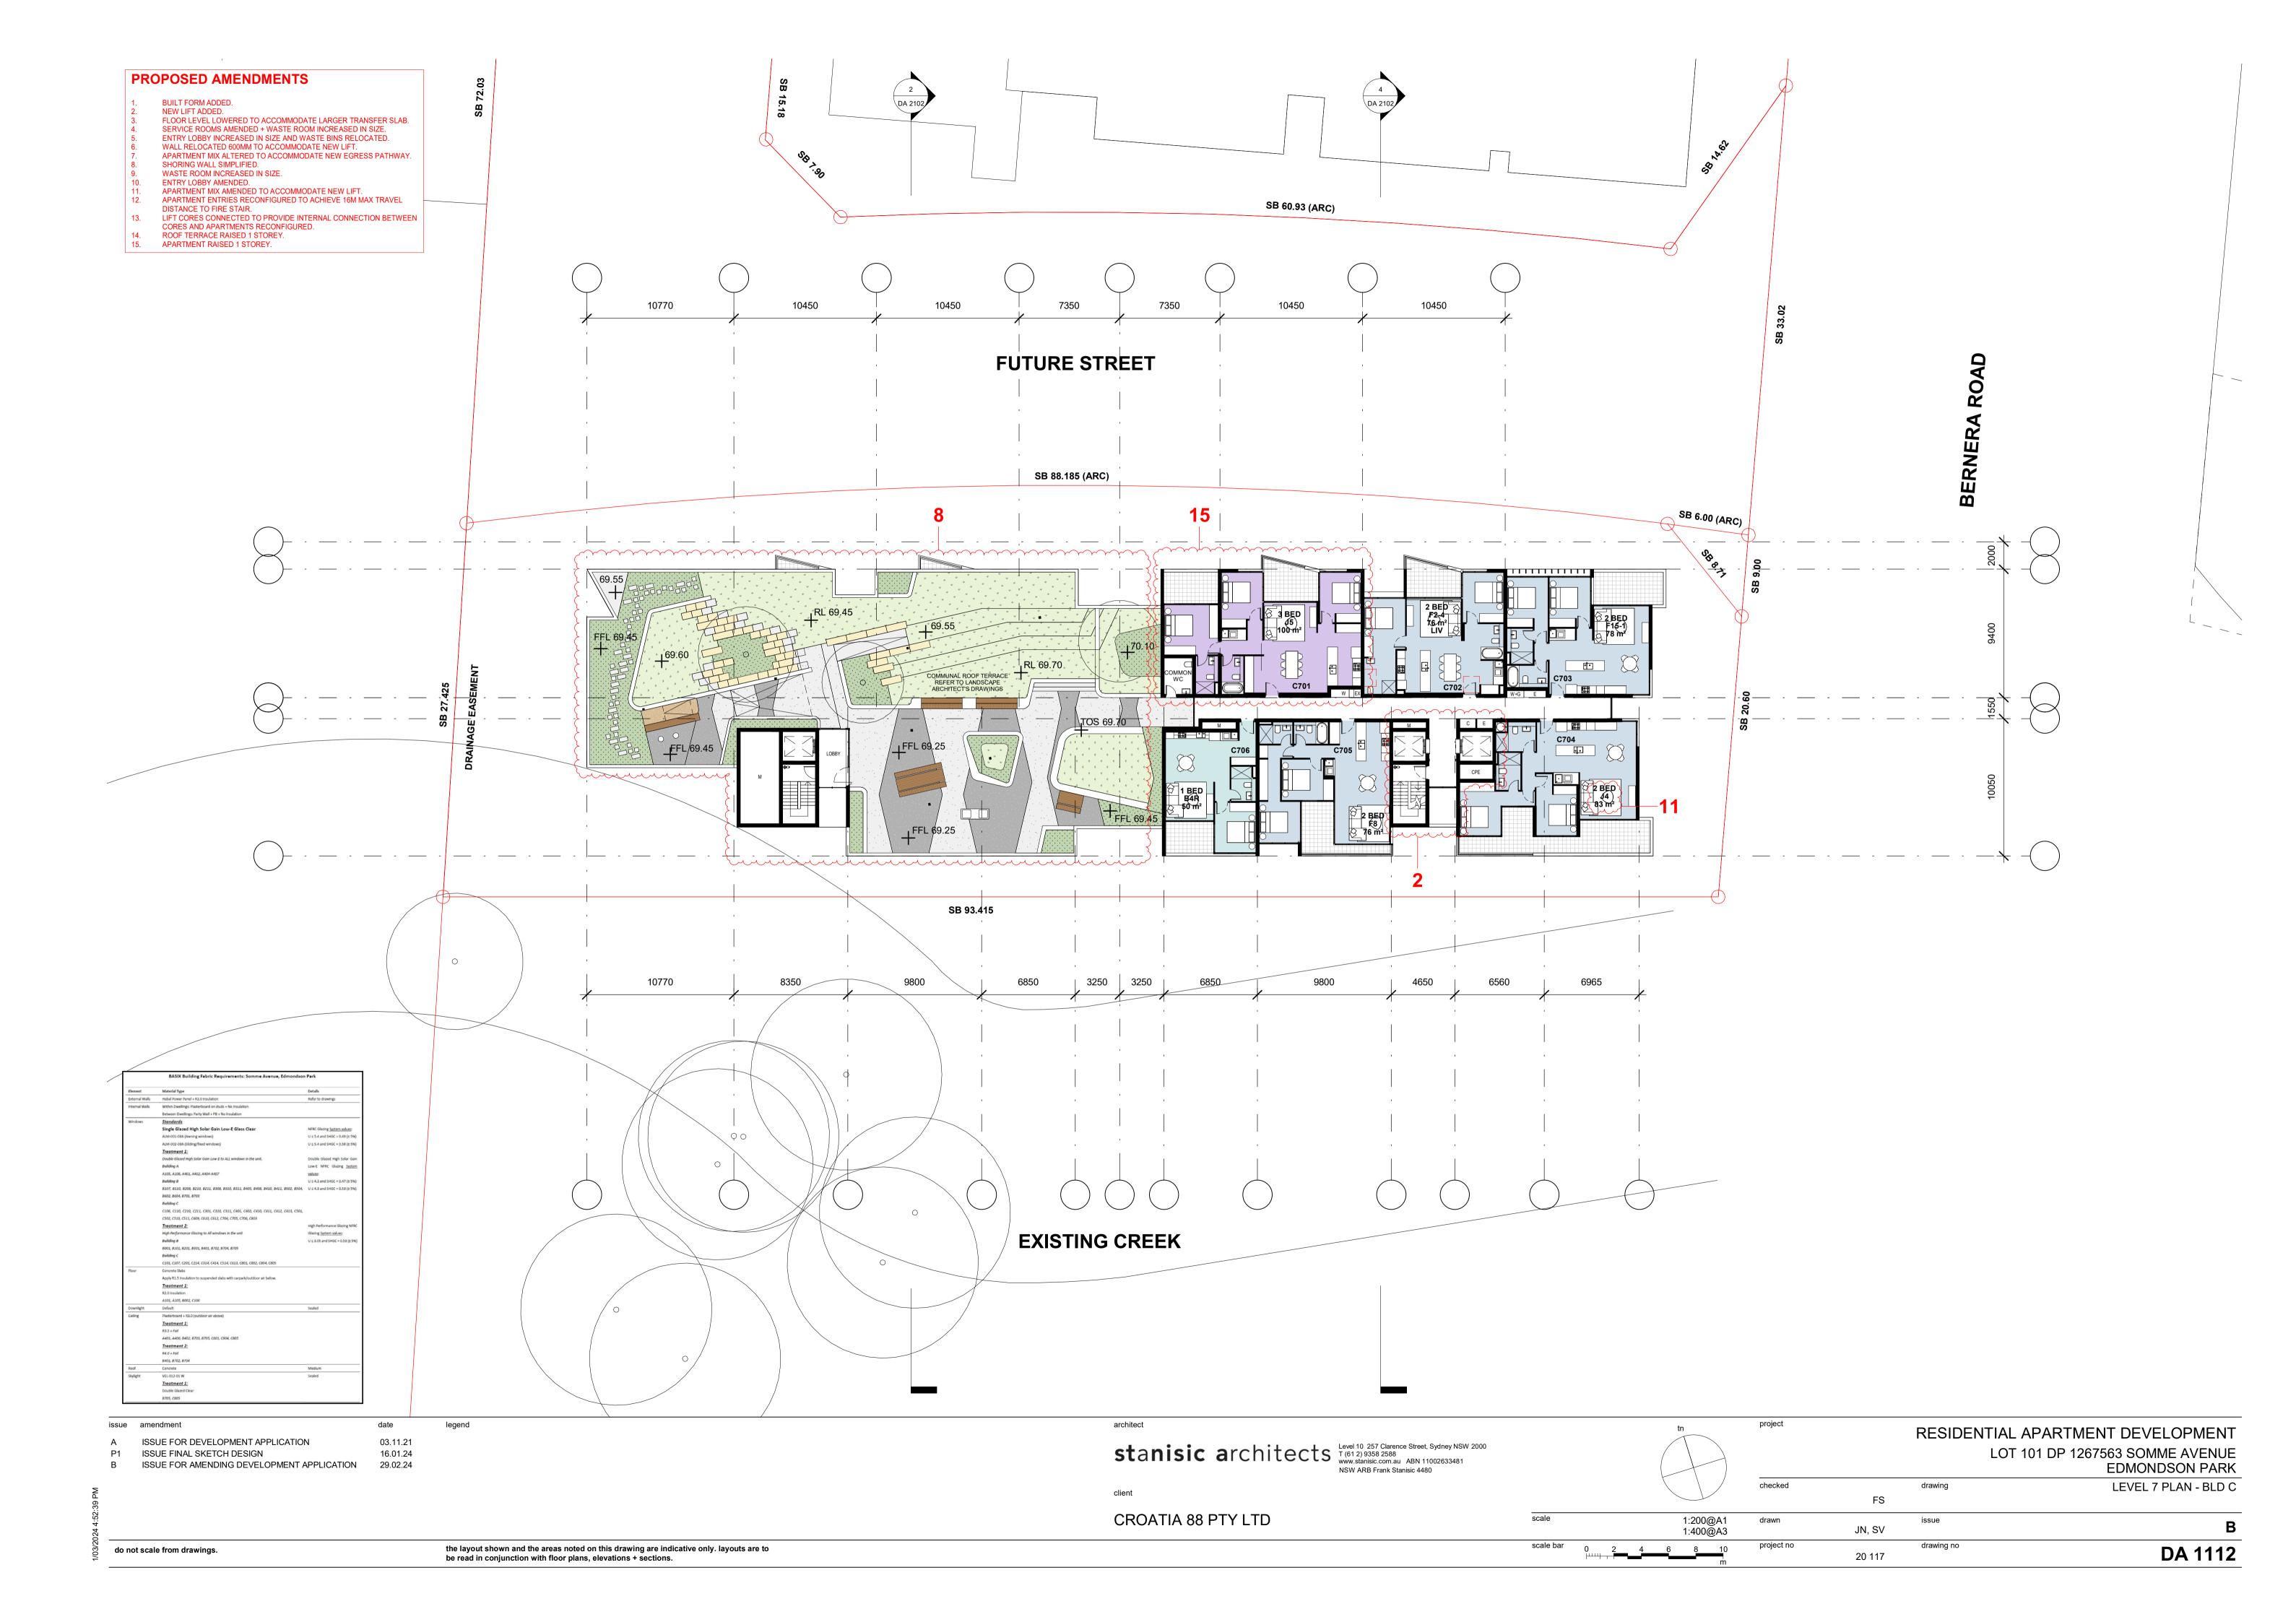




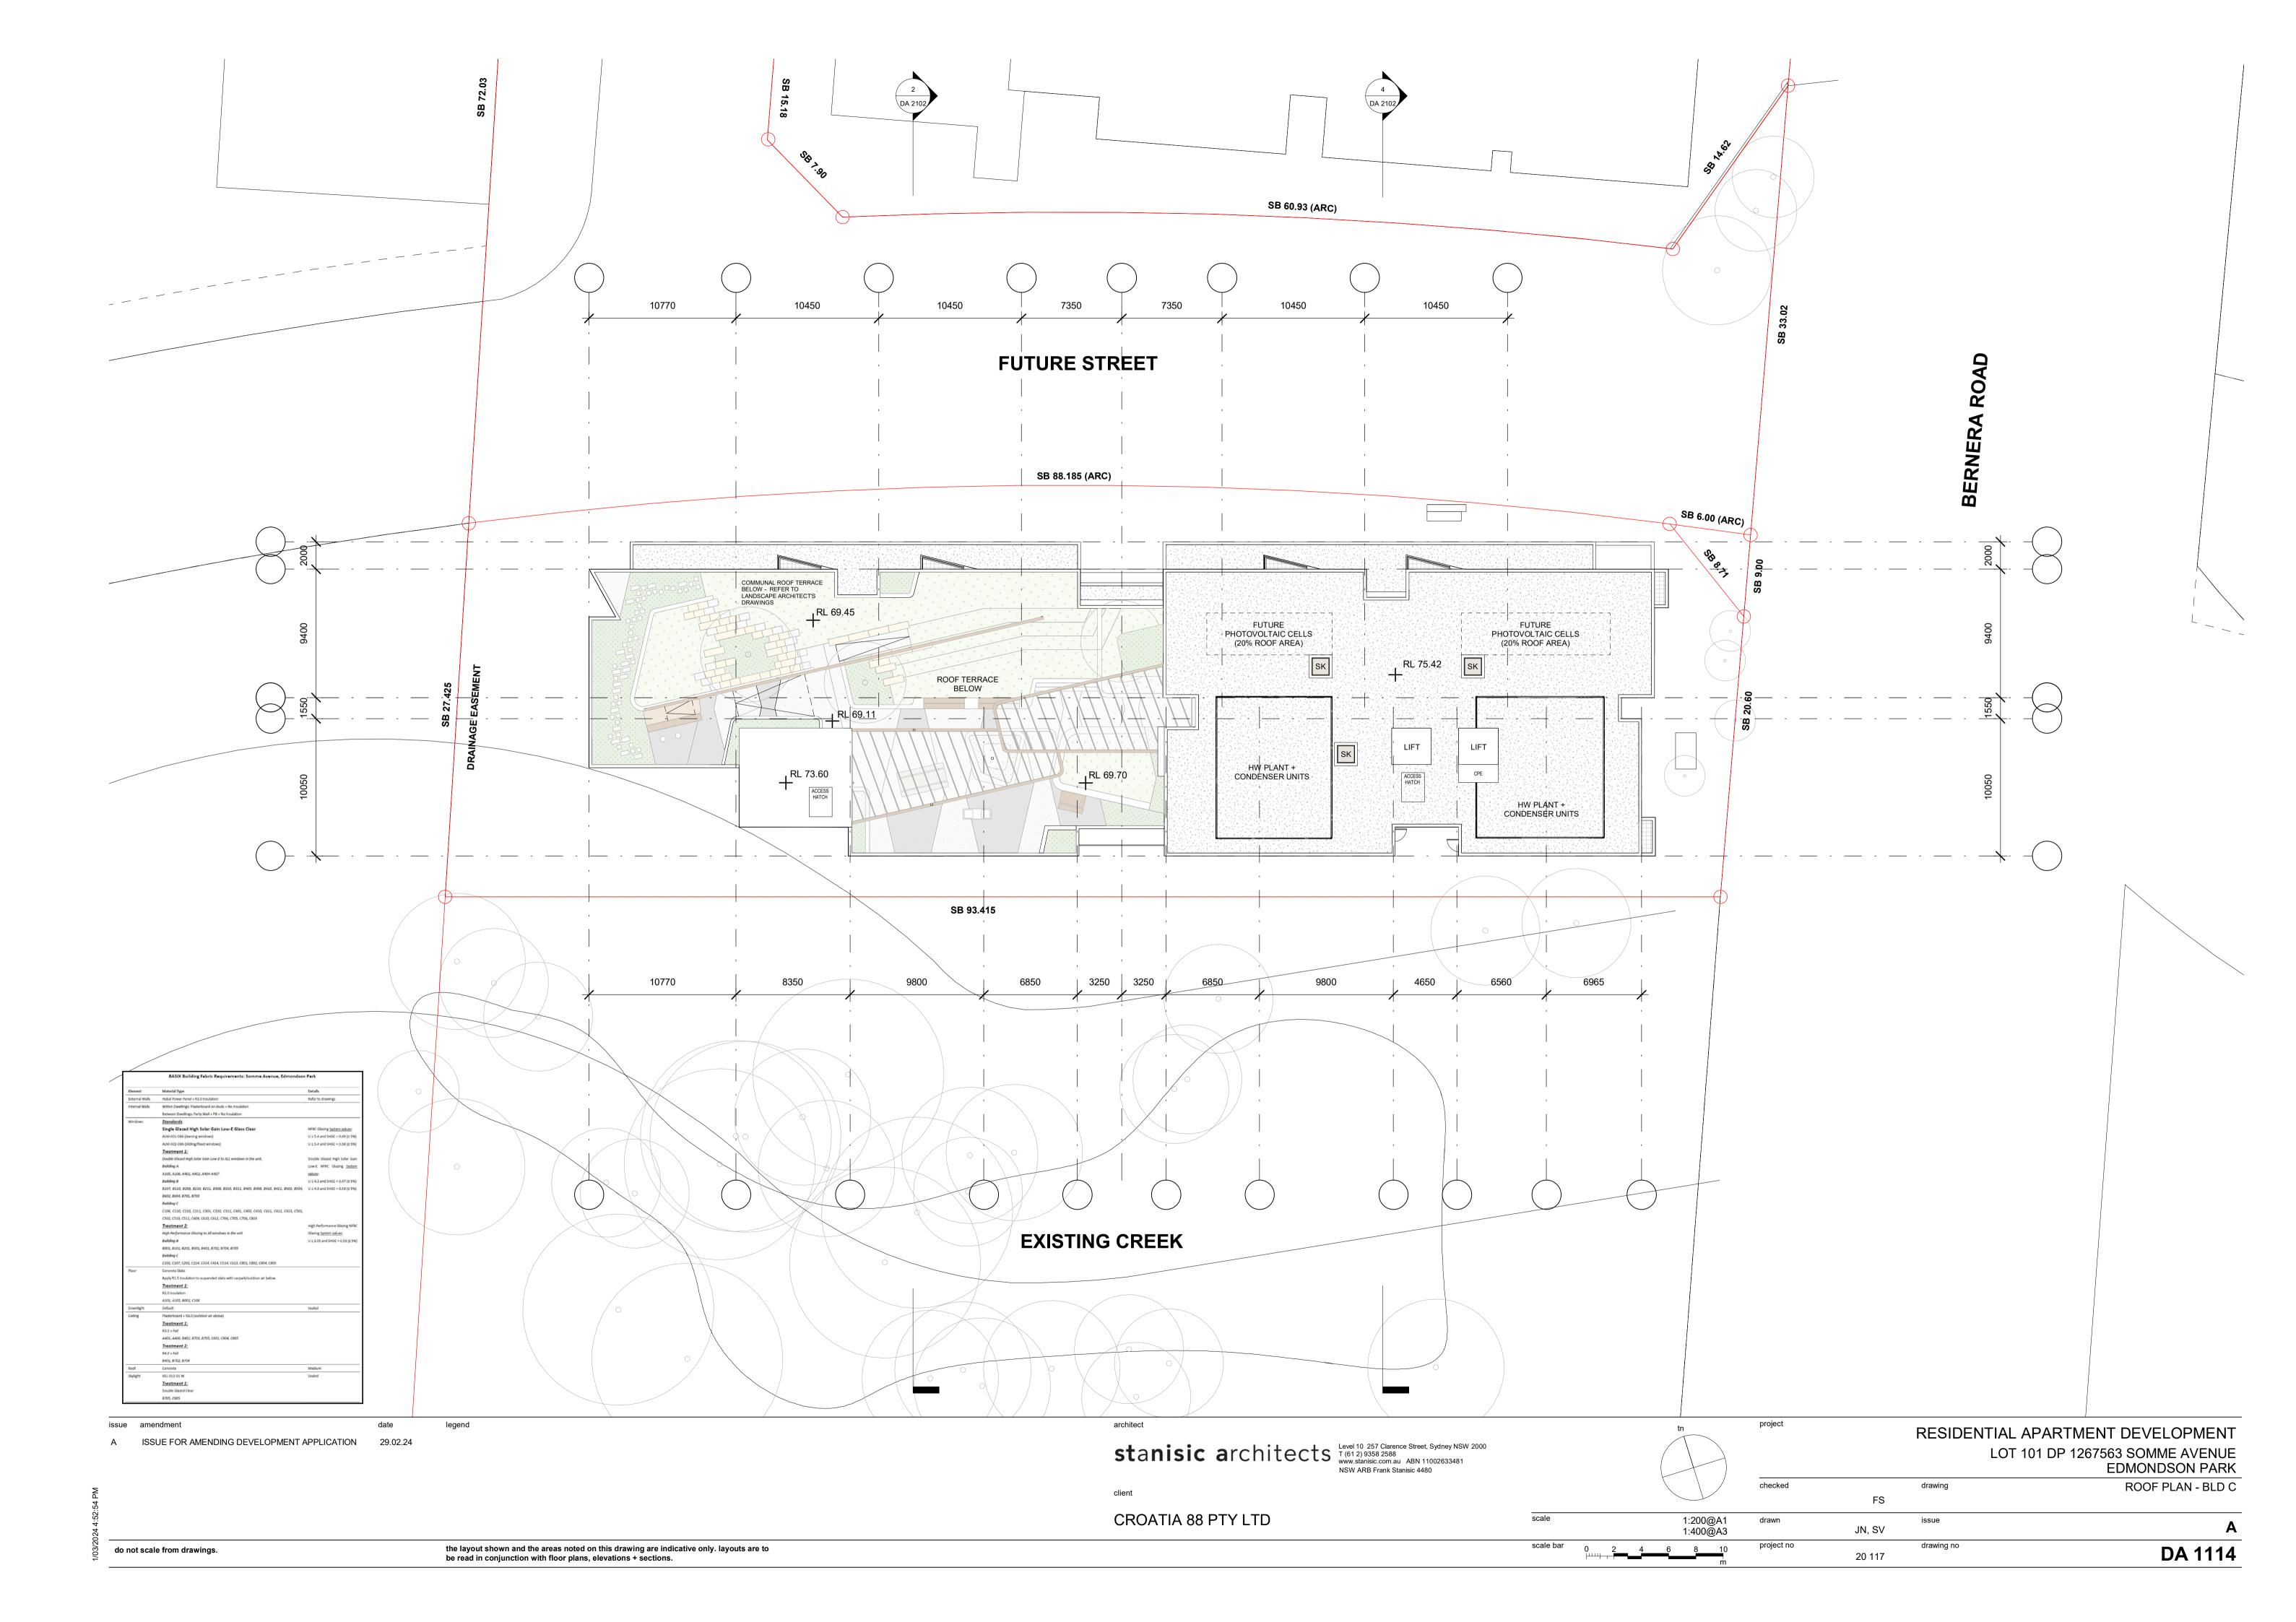




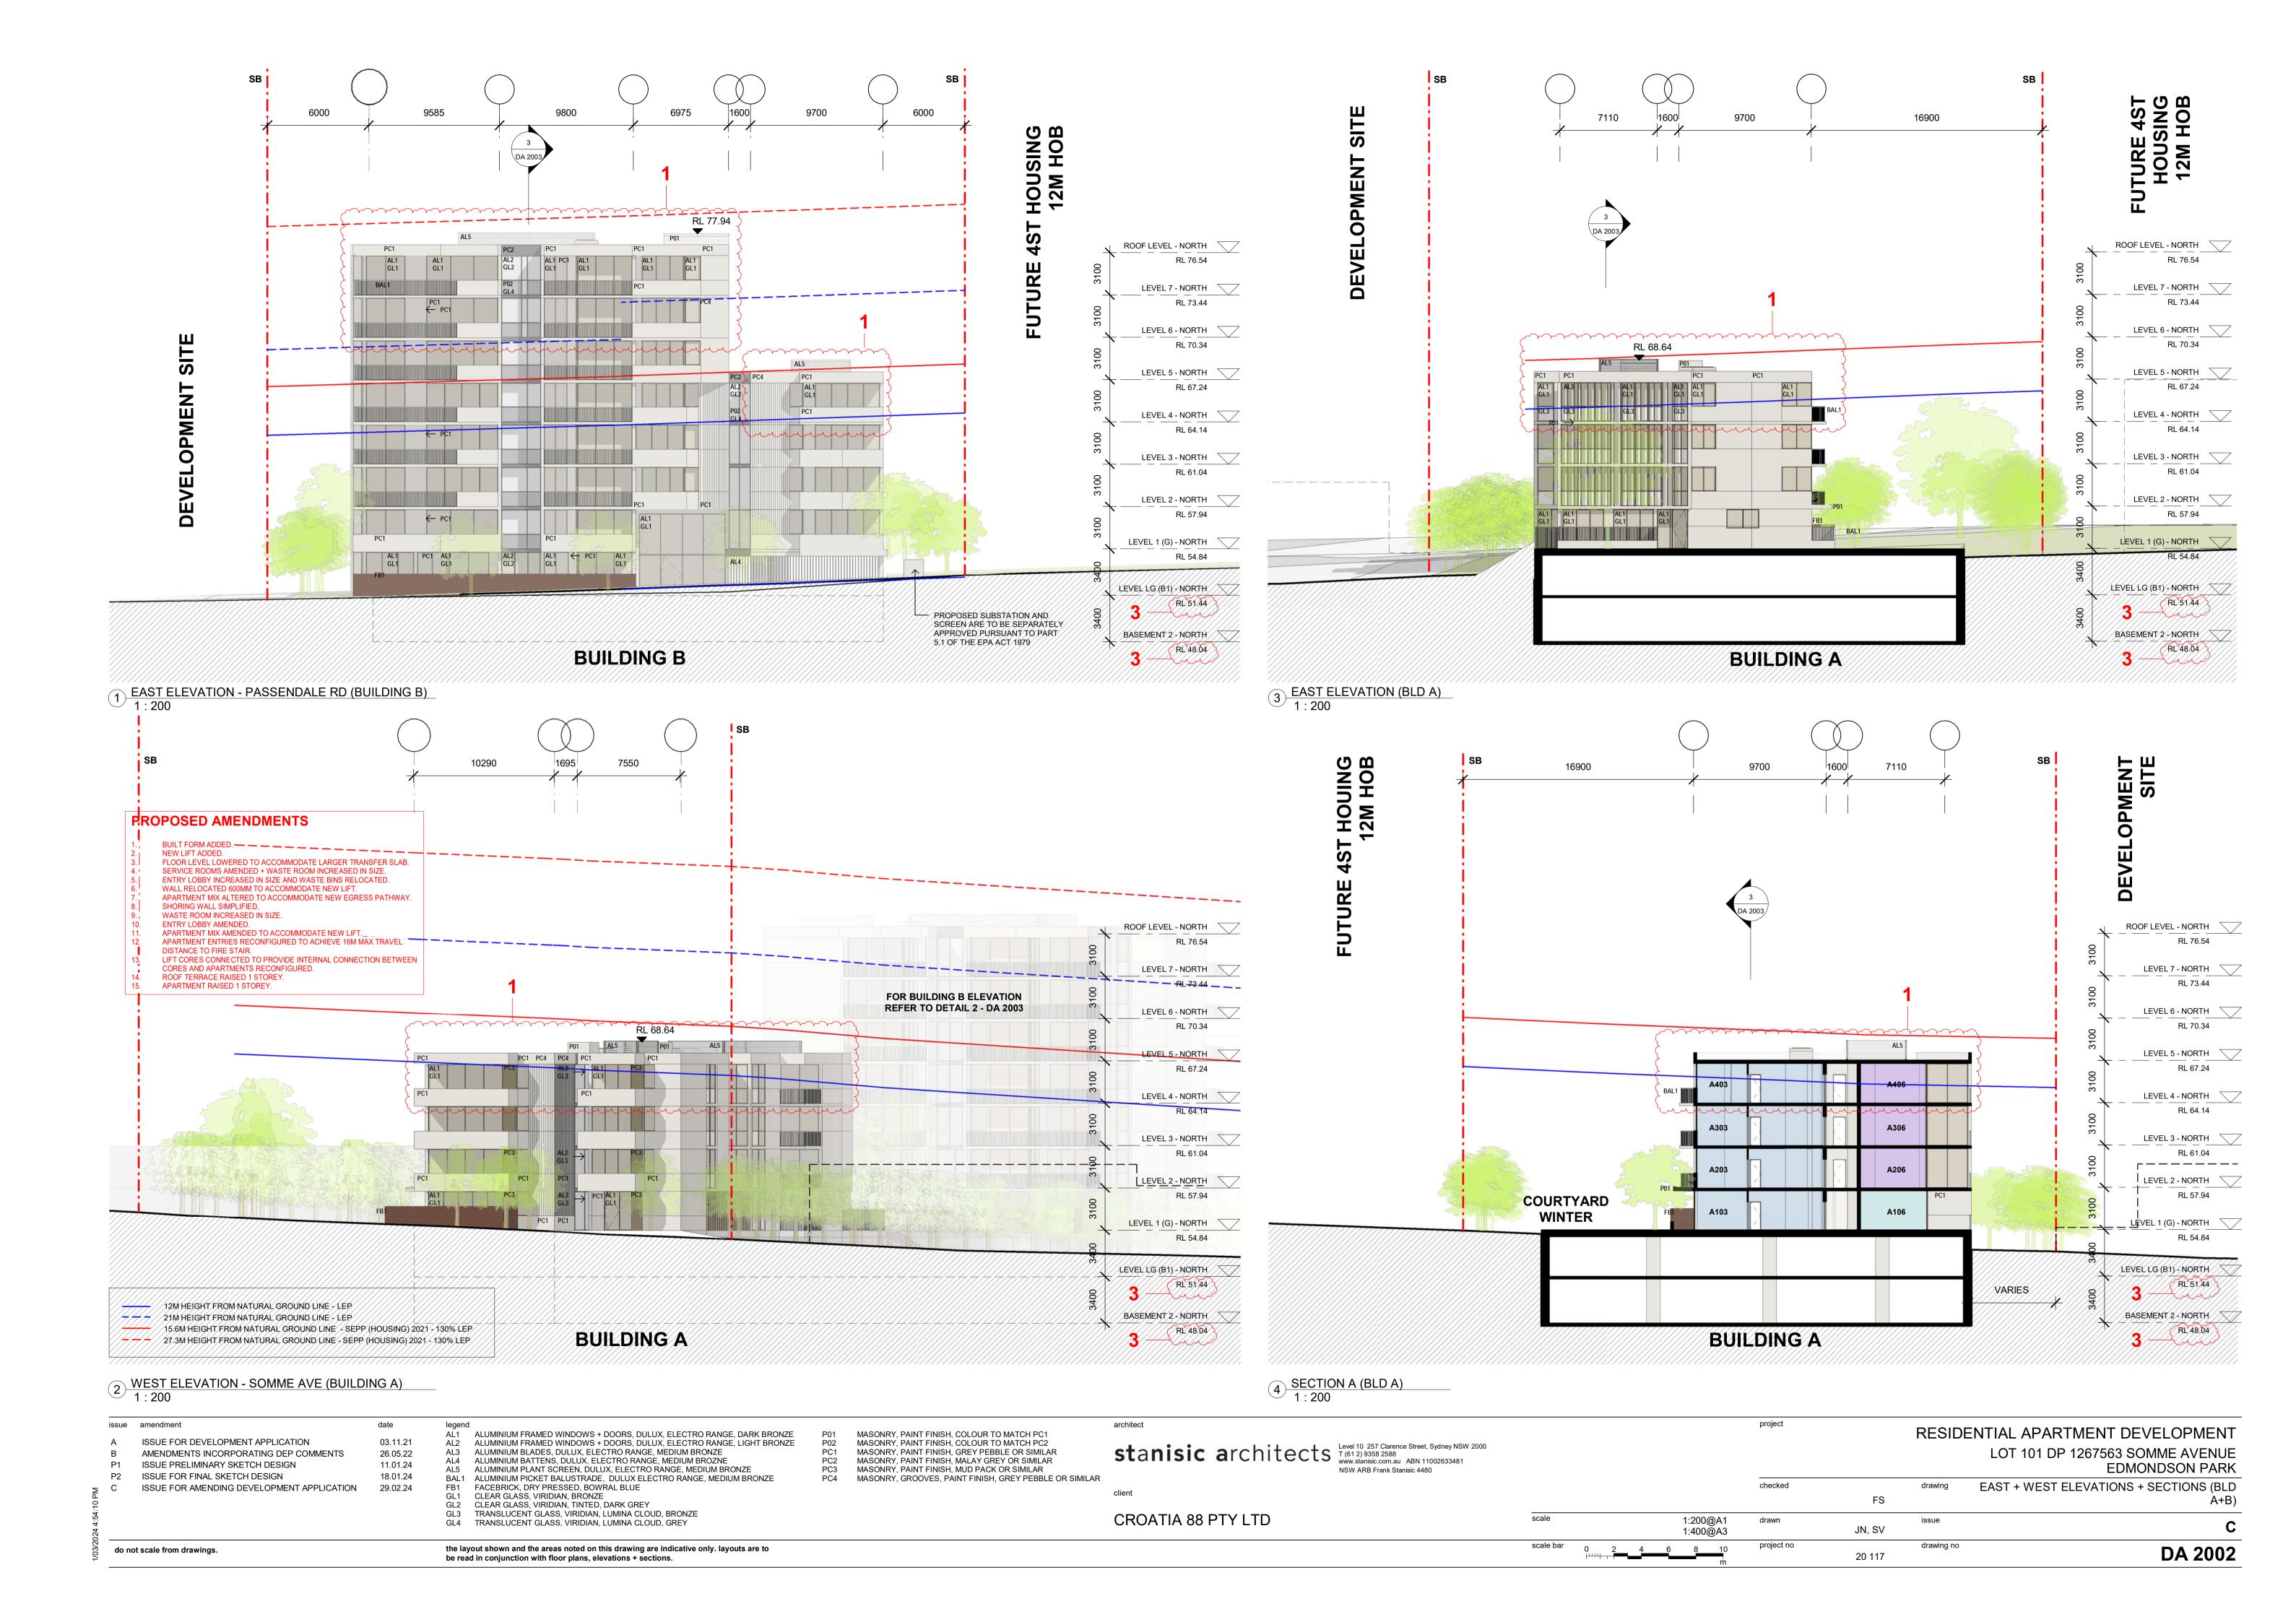

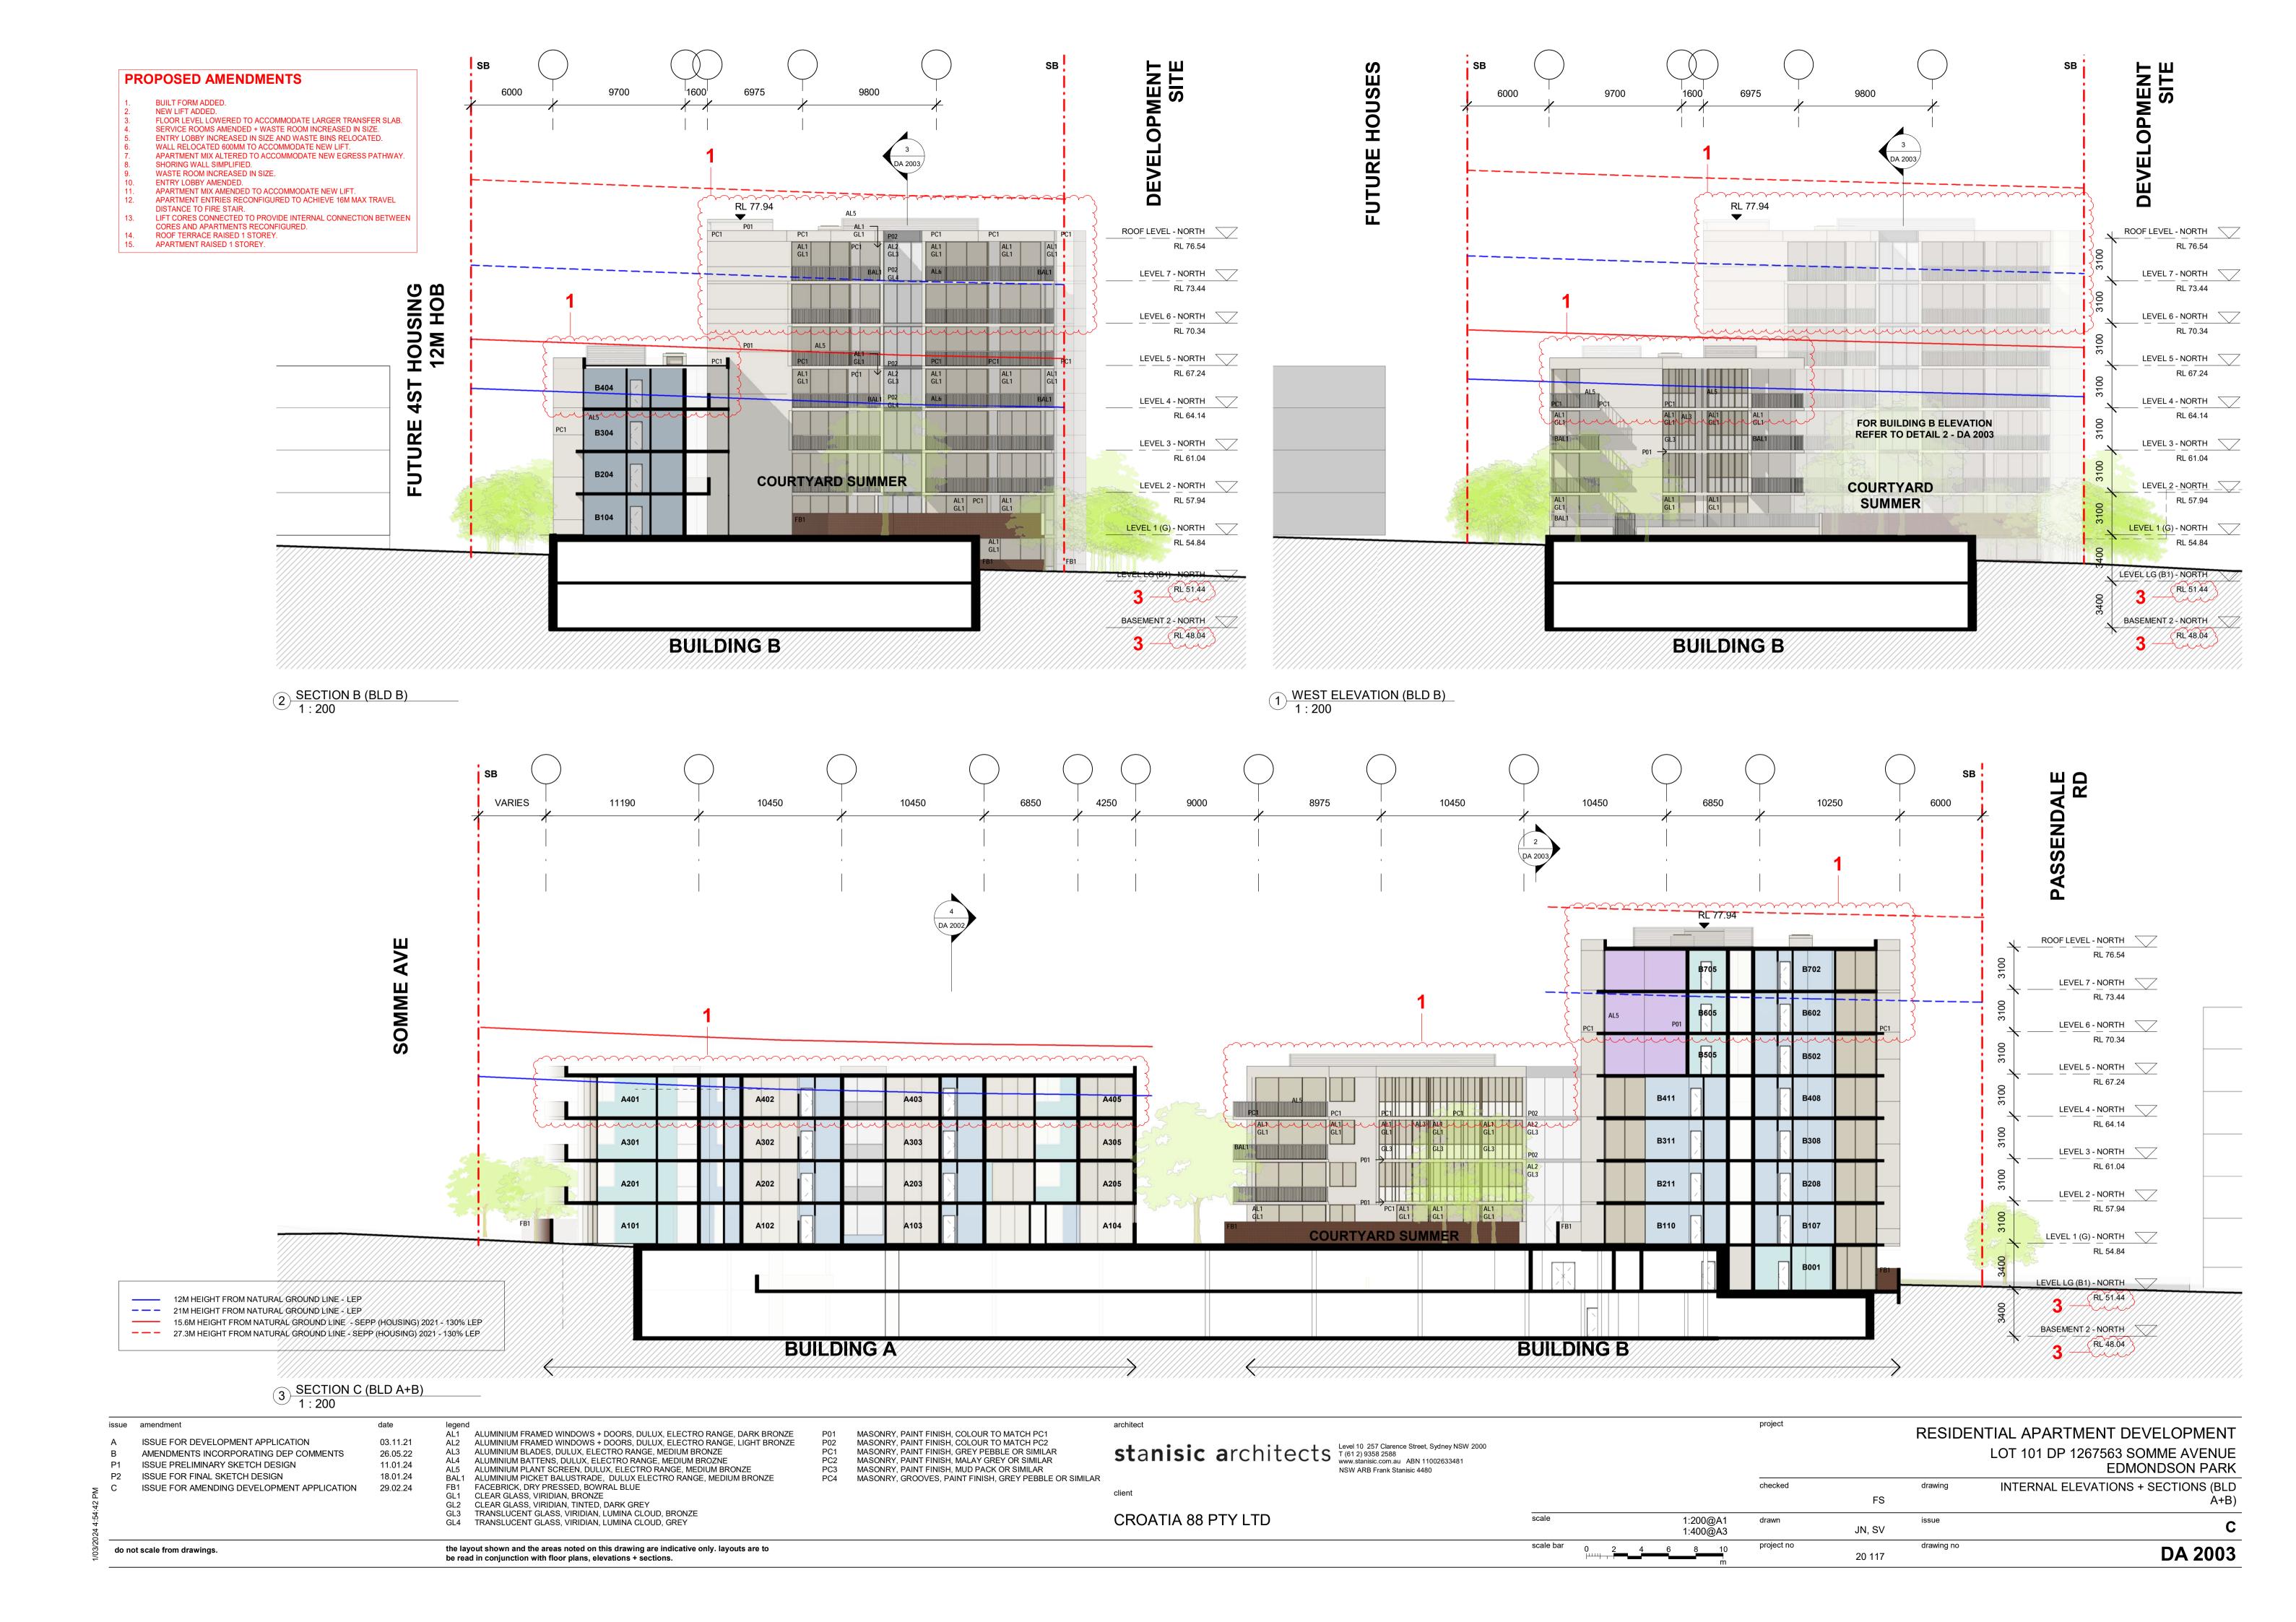



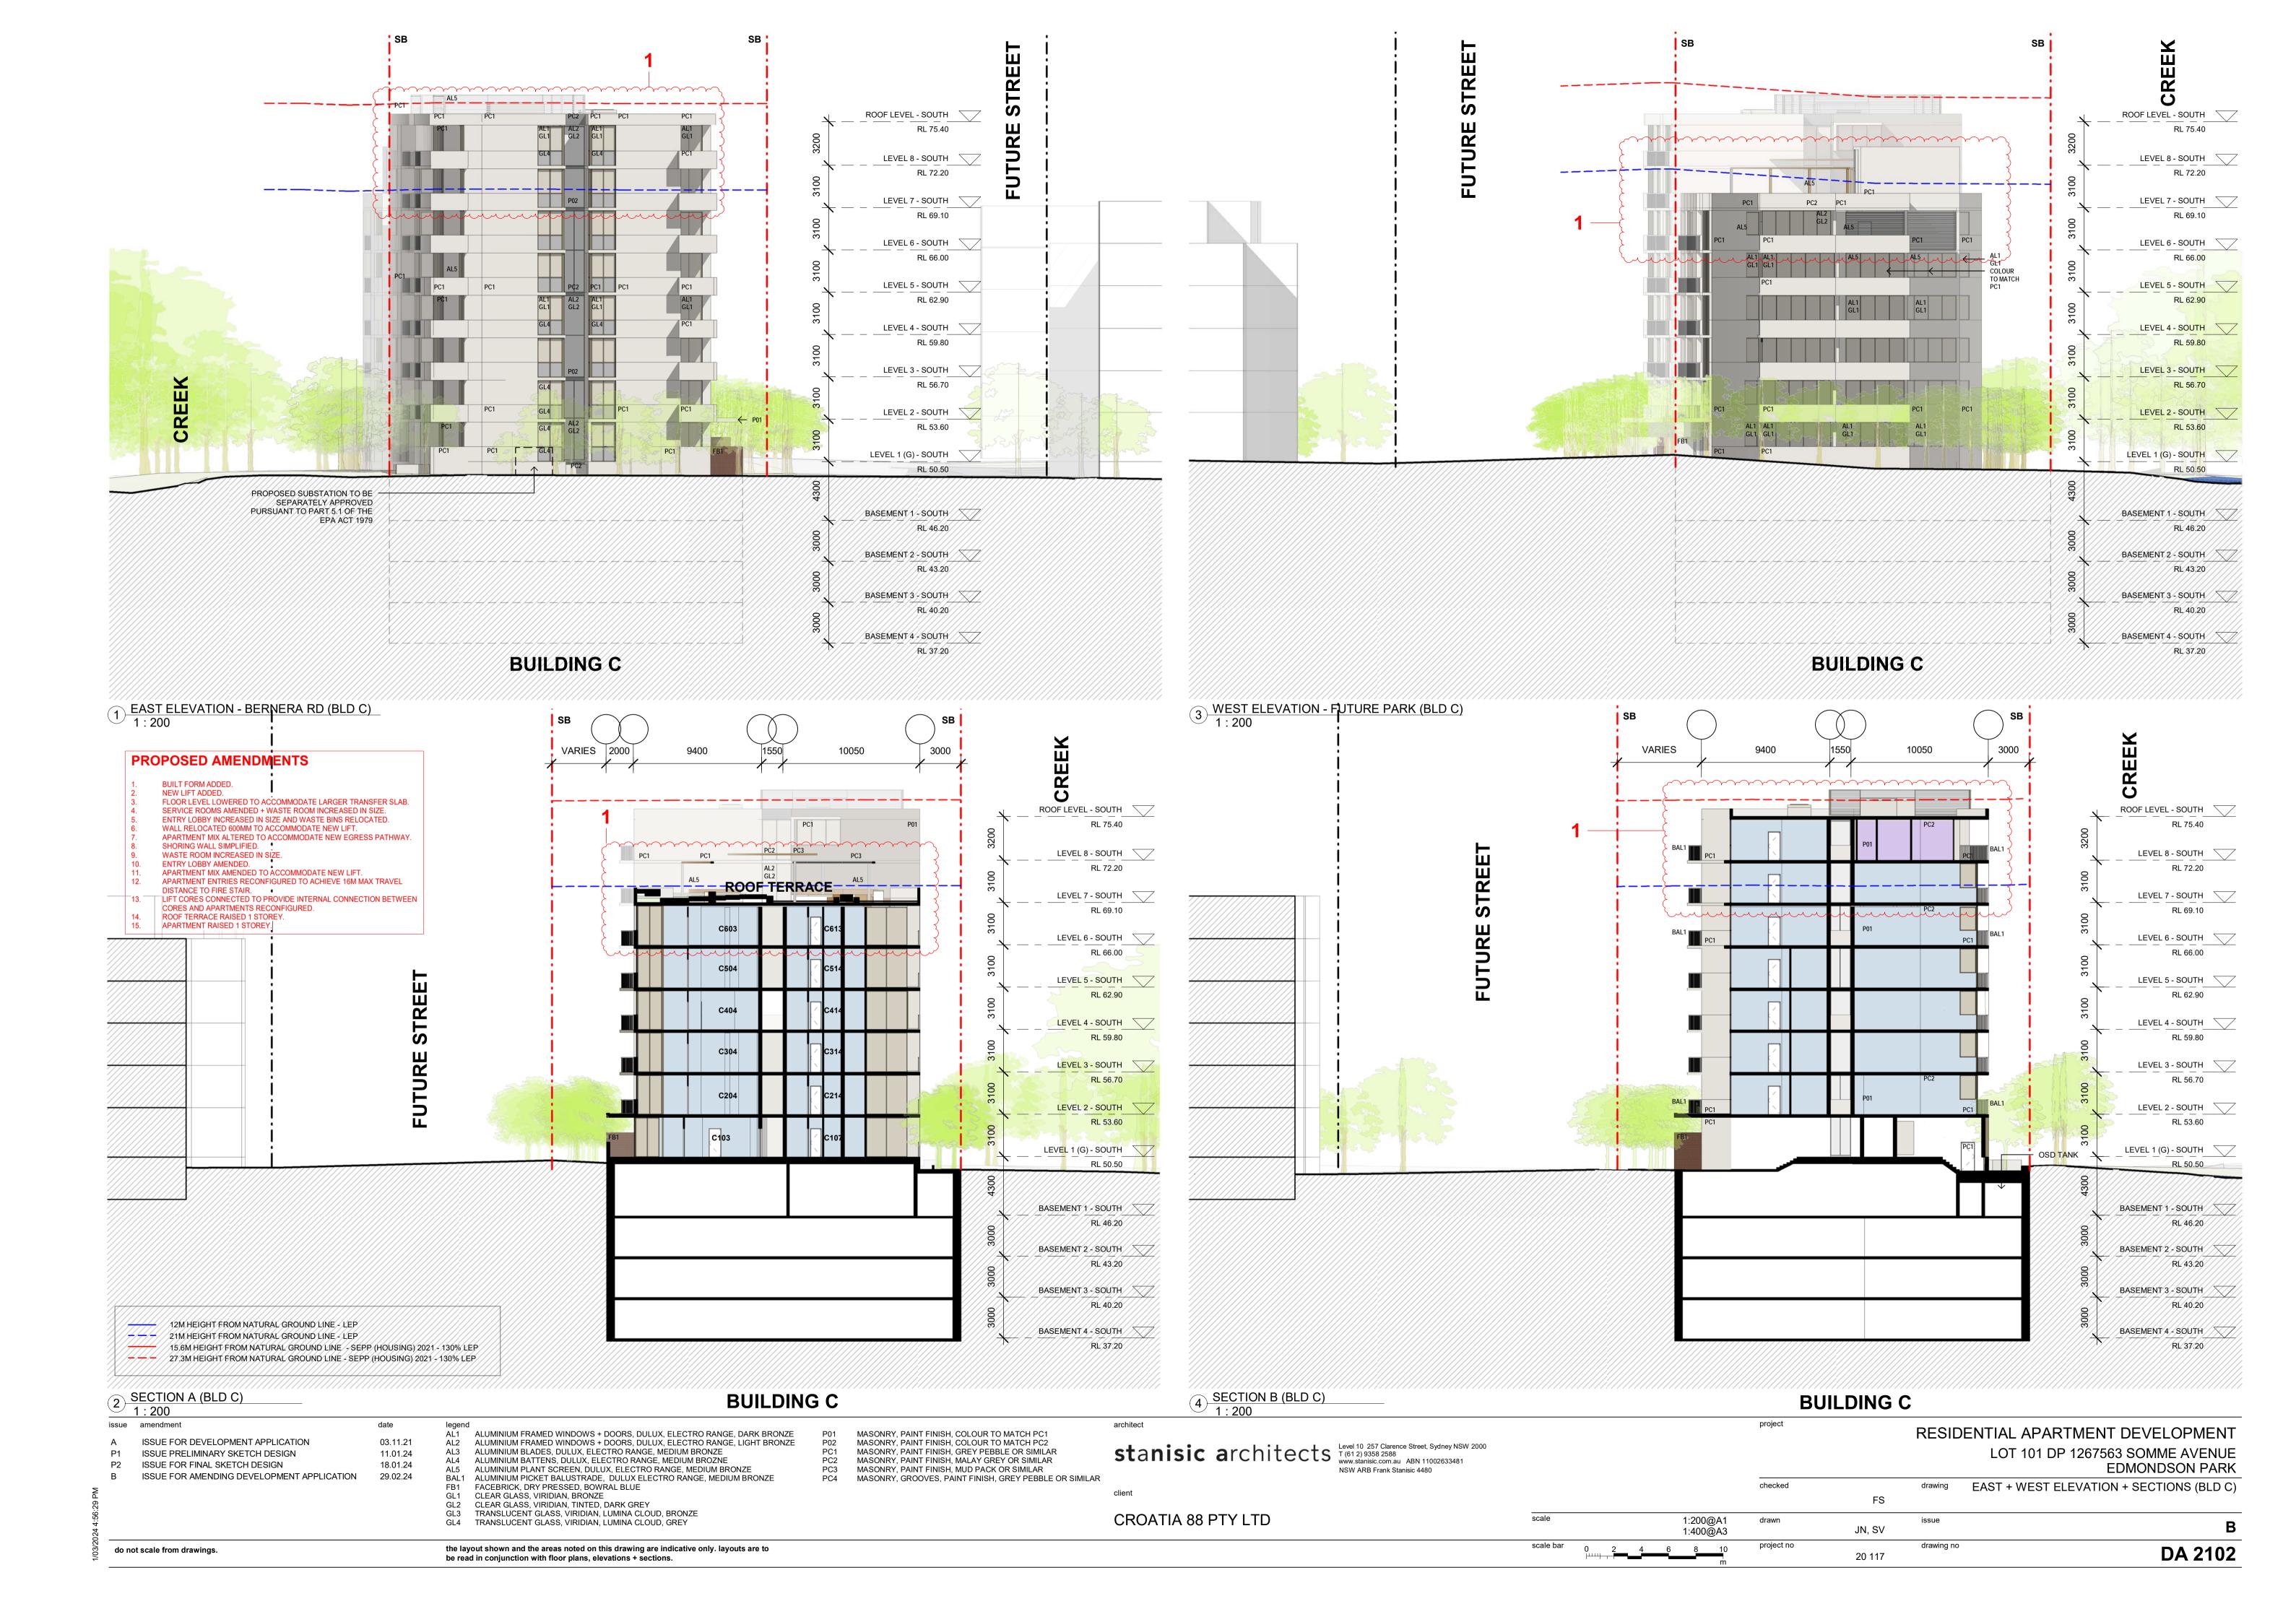









^ WINTER SOLSTICE 0900



WINTER SOLSTICE 1000

^ WINTER SOLSTICE

1200



^ WINTER SOLSTICE 1100

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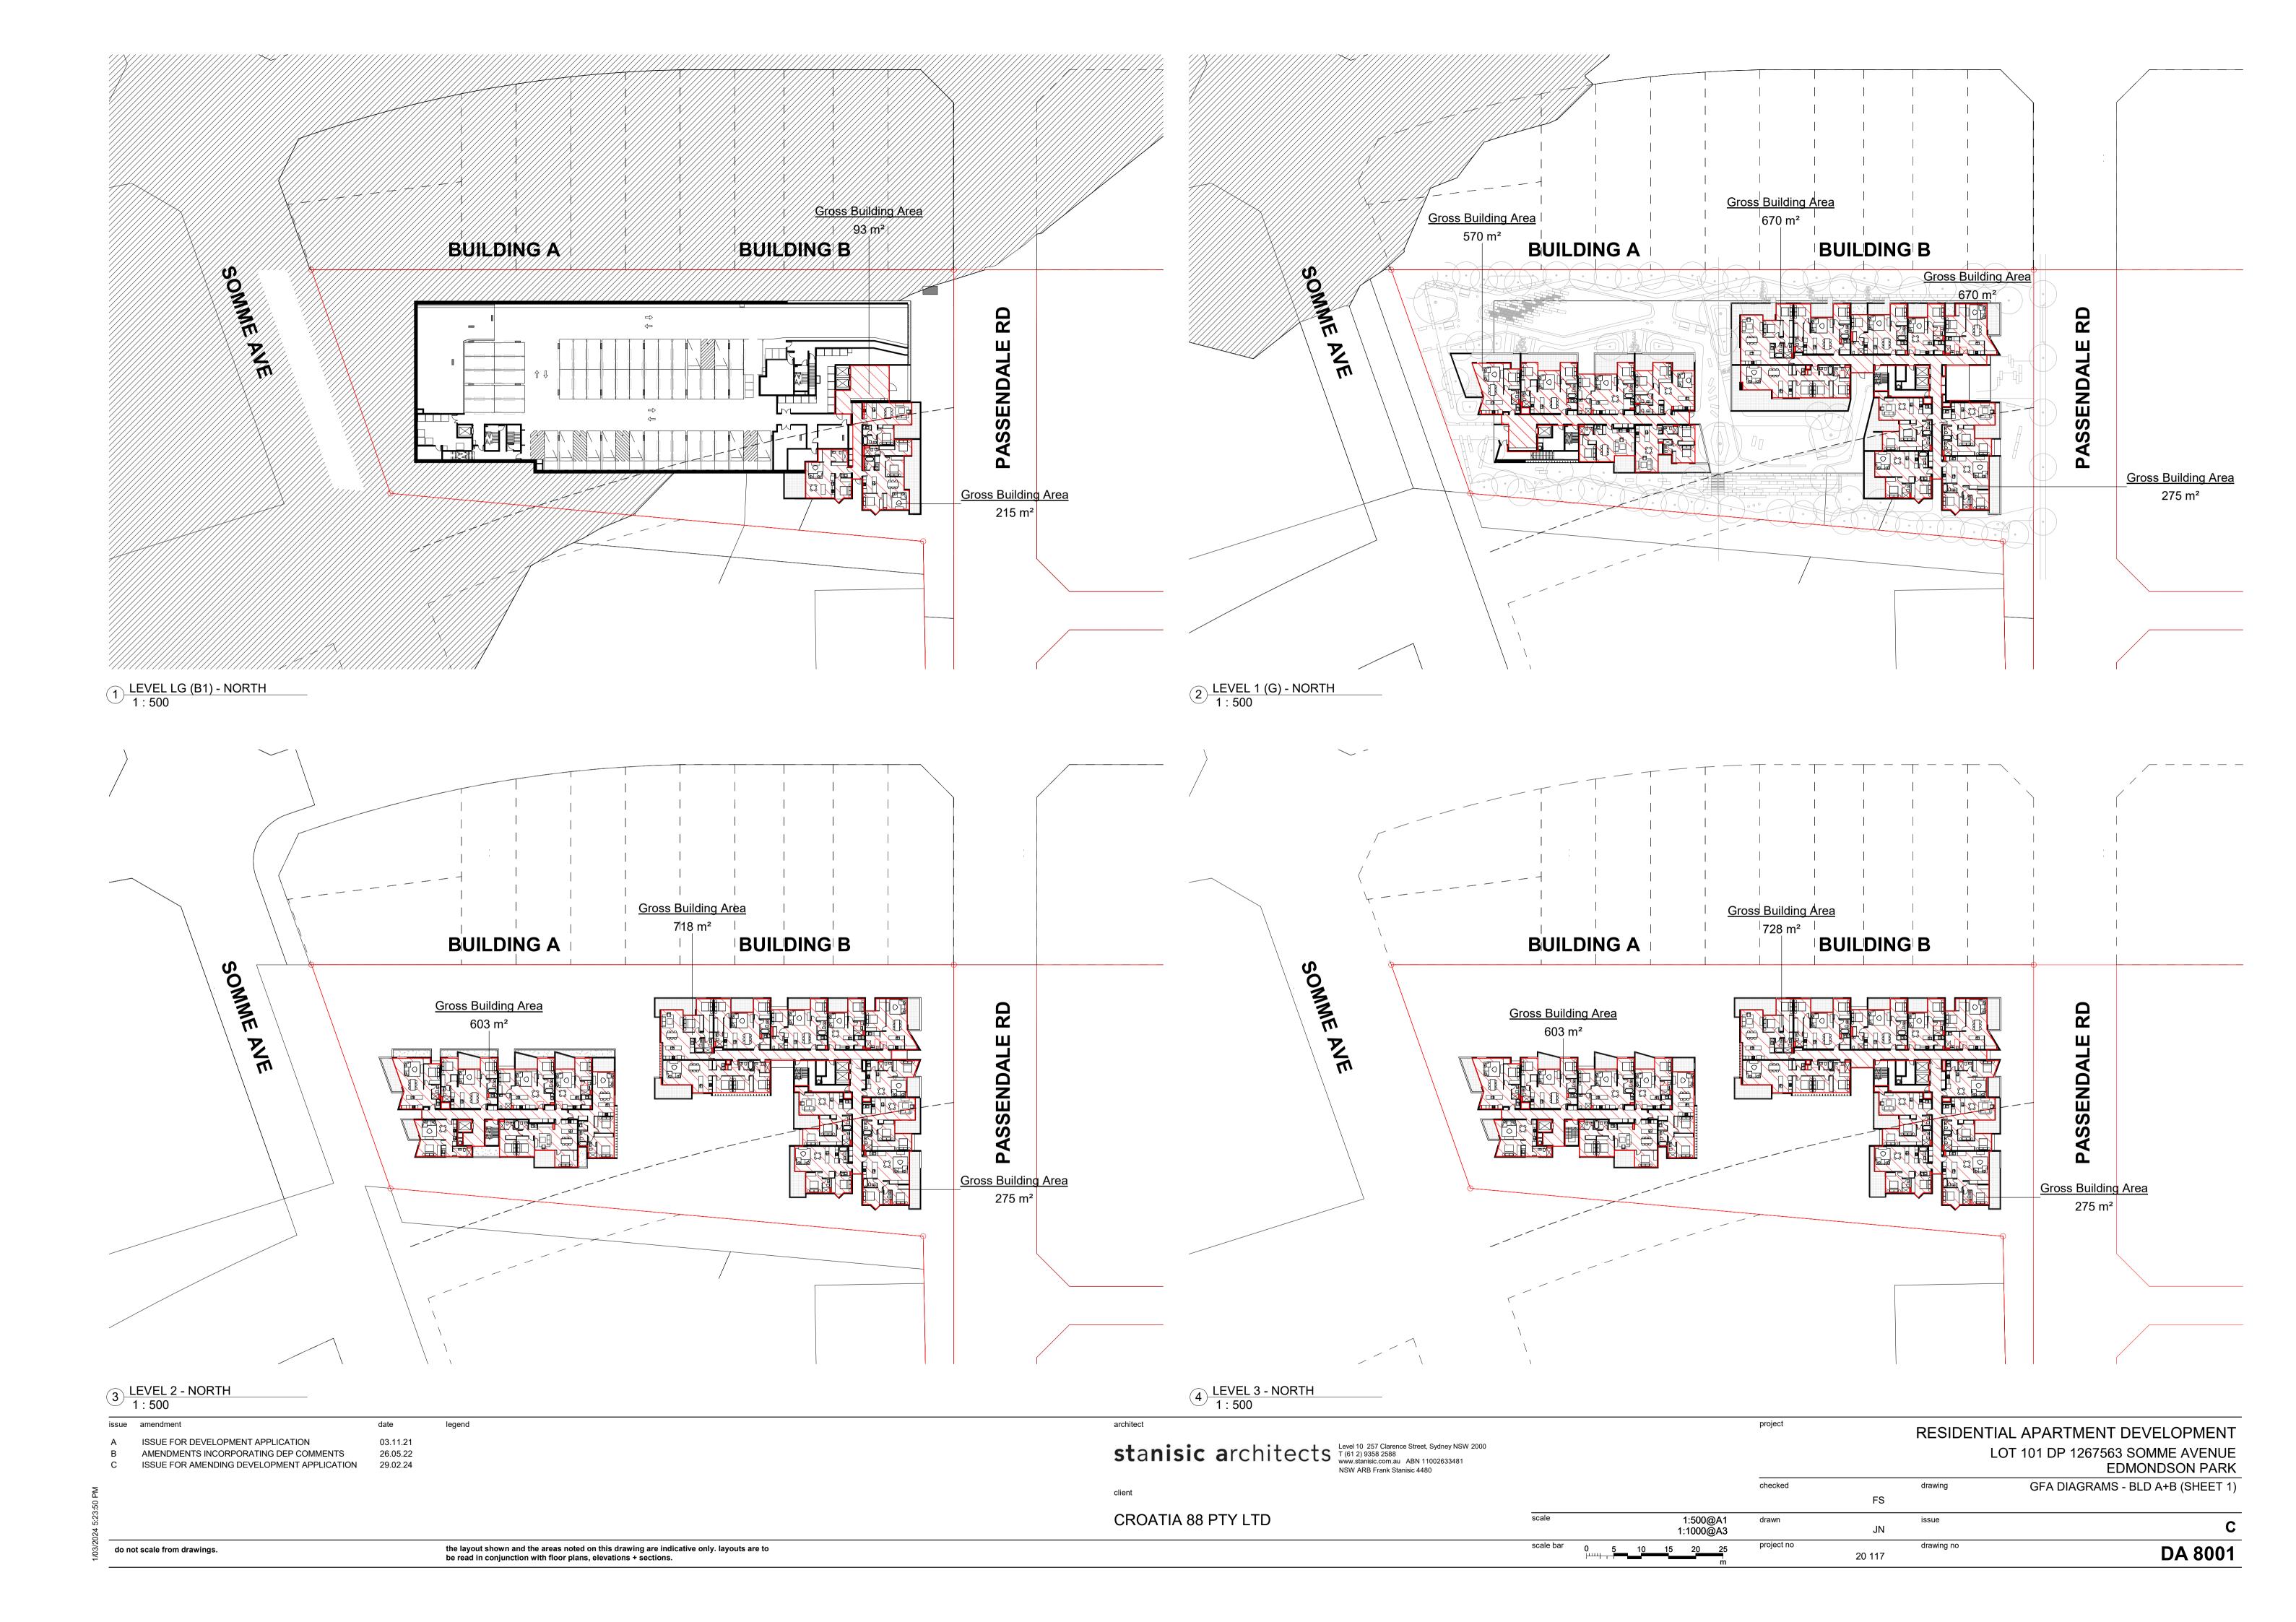
WINTER SOLSTICE1300





^ WINTER SOLSTICE 1400

^ WINTER SOLSTICE 1500

issue amendment	date	legend	architect	project	RESIDEN ⁻	TIAL APARTMENT DEVELOPMENT	
A ISSUE FOR DEVELOPMENT APPLICATION P1 ISSUE FOR FINAL SKETCH DESIGN B ISSUE FOR AMENDING DEVELOPMENT APPLICA	03.11.21 18.01.24 ATION 29.02.24		stanisic architects Level 10 257 Clarence Street, Sy T (61 2) 9358 2588 www.stanisic.com.au ABN 1100 NSW ARB Frank Stanisic 4480				LOT 101 DP 1267563 SOMME AVENUE EDMONDSON PARK
M G 9			client		checked	drawing JN	SUN EYE VIEWS - WINTER SOLSTICE (13.00-15.00)
124 5:23:			CROATIA 88 PTY LTD	scale	NTS drawn	issue SV	В
07/08 do not scale from drawings.		the layout shown and the areas noted on this drawing are indicative only. layouts are to be read in conjunction with floor plans, elevations + sections.		scale bar	project no	drawing no 20 117	DA 5002



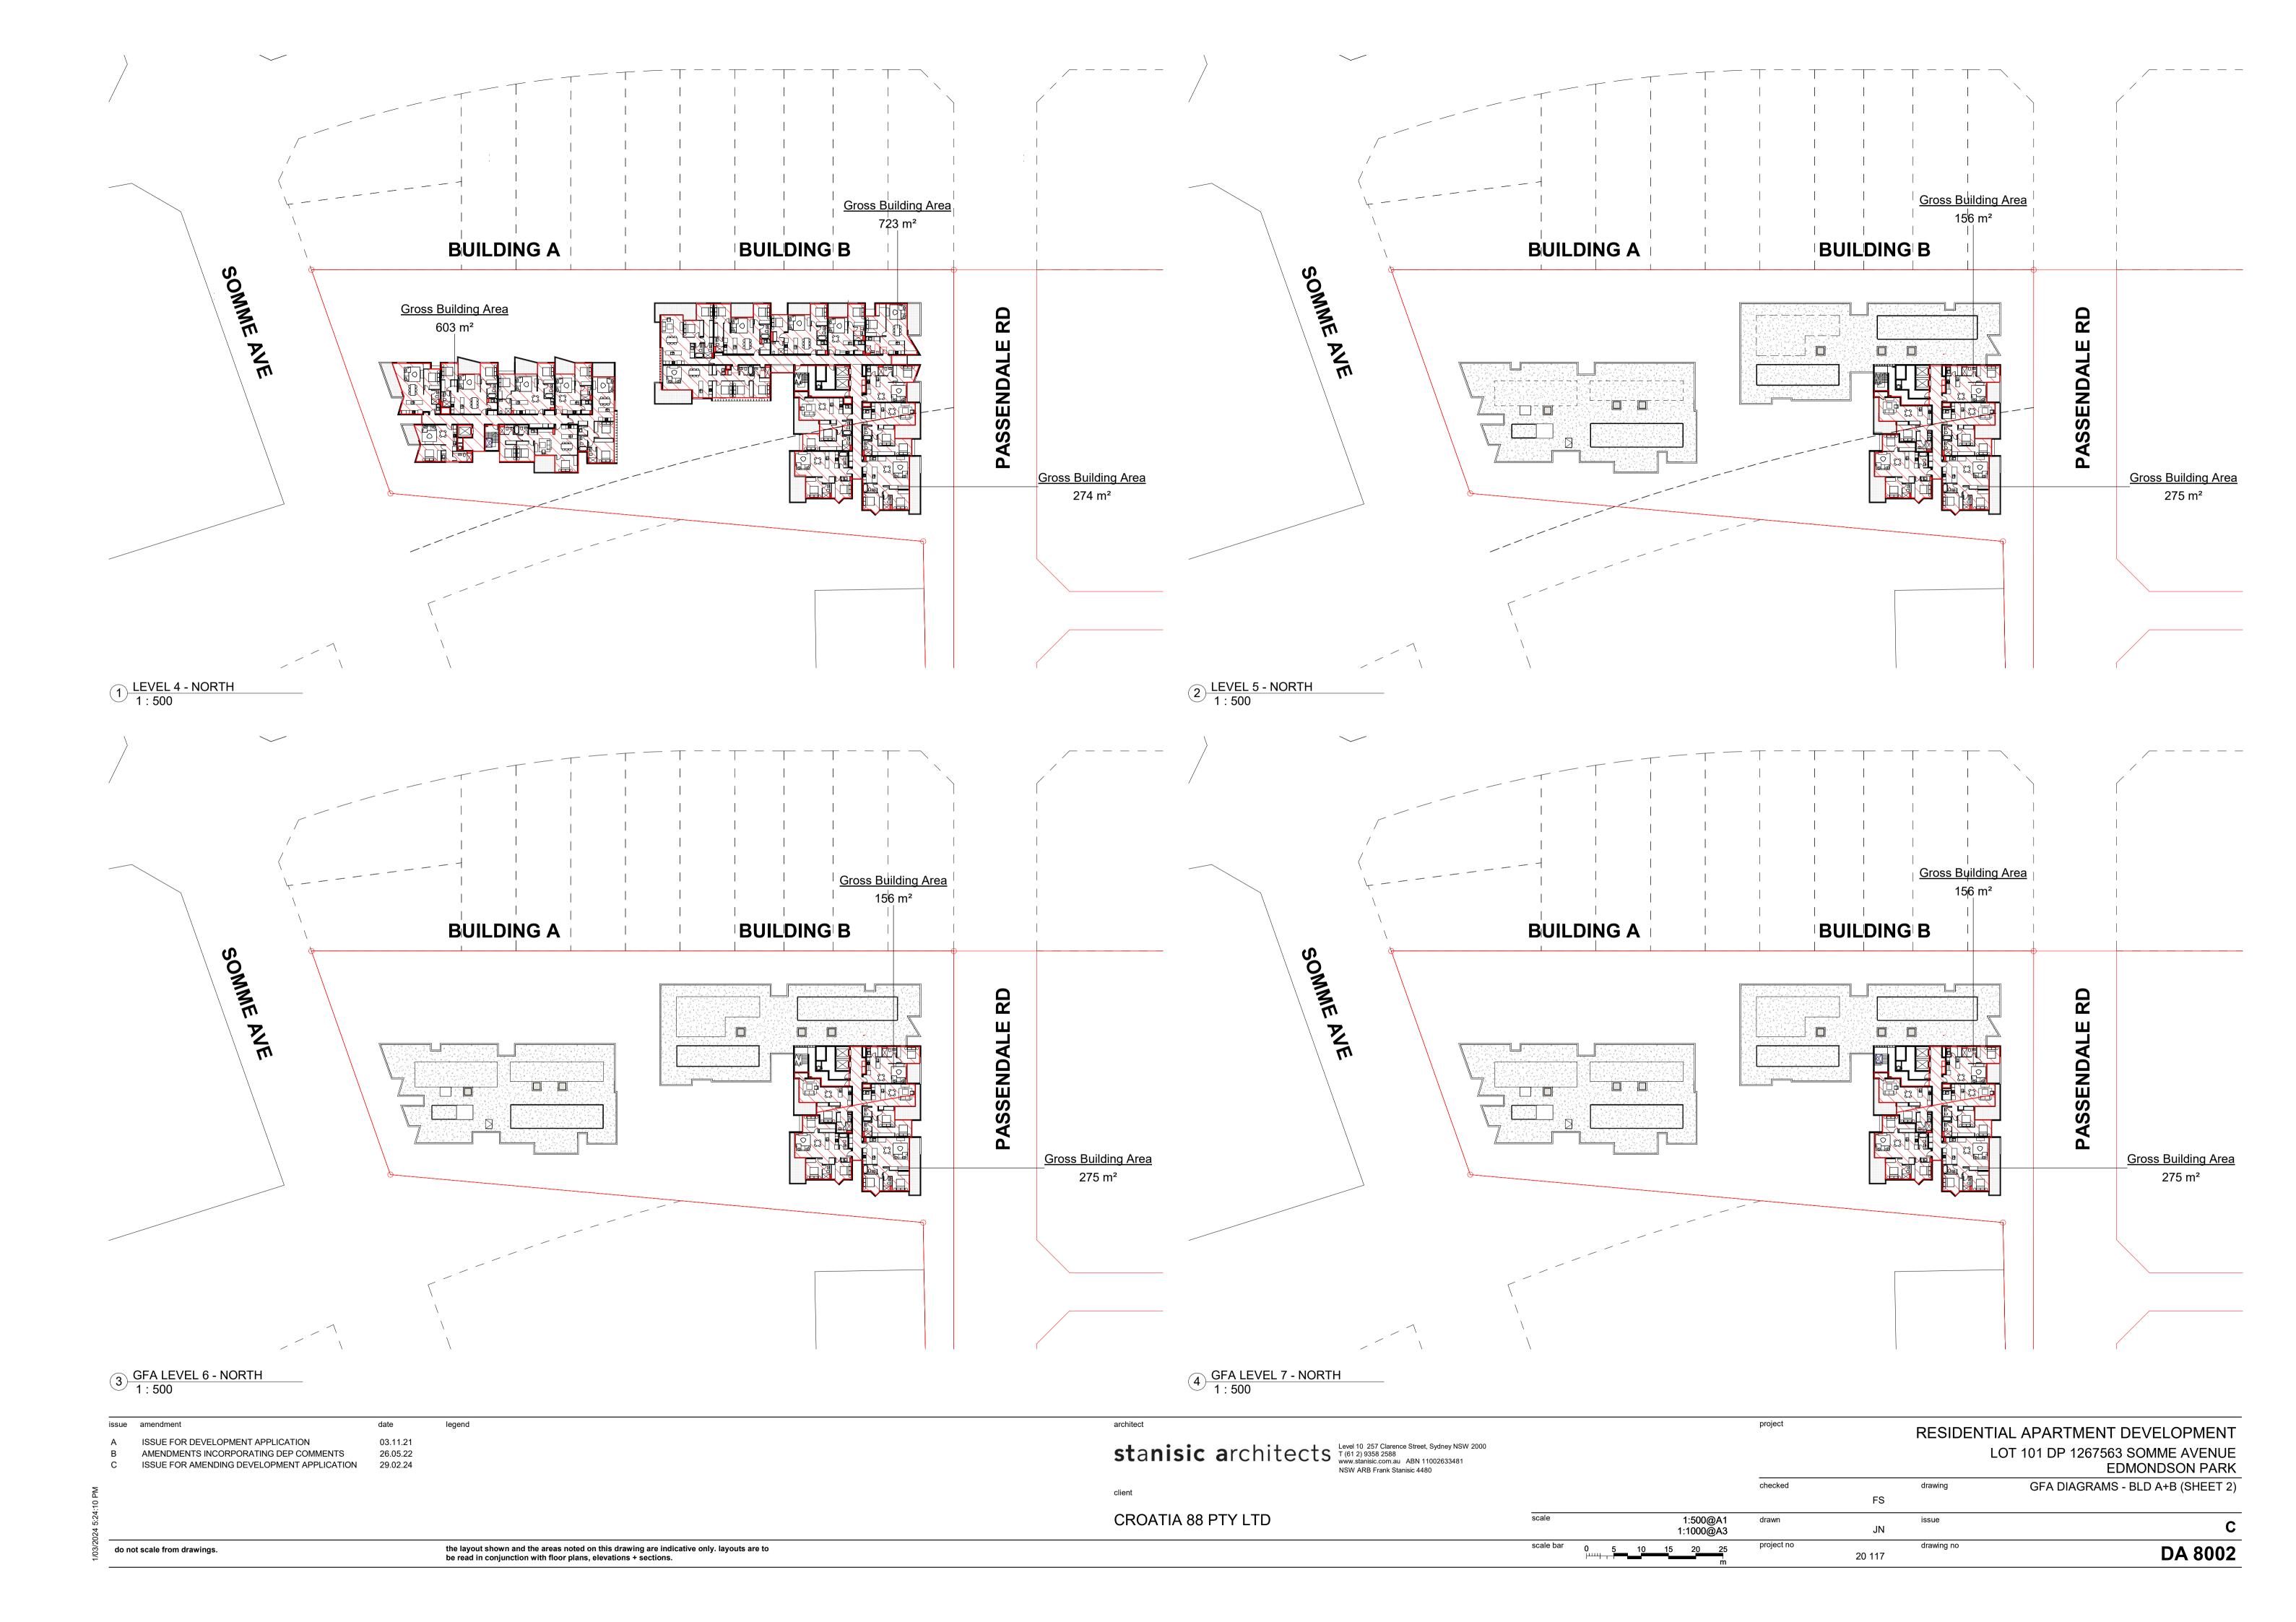

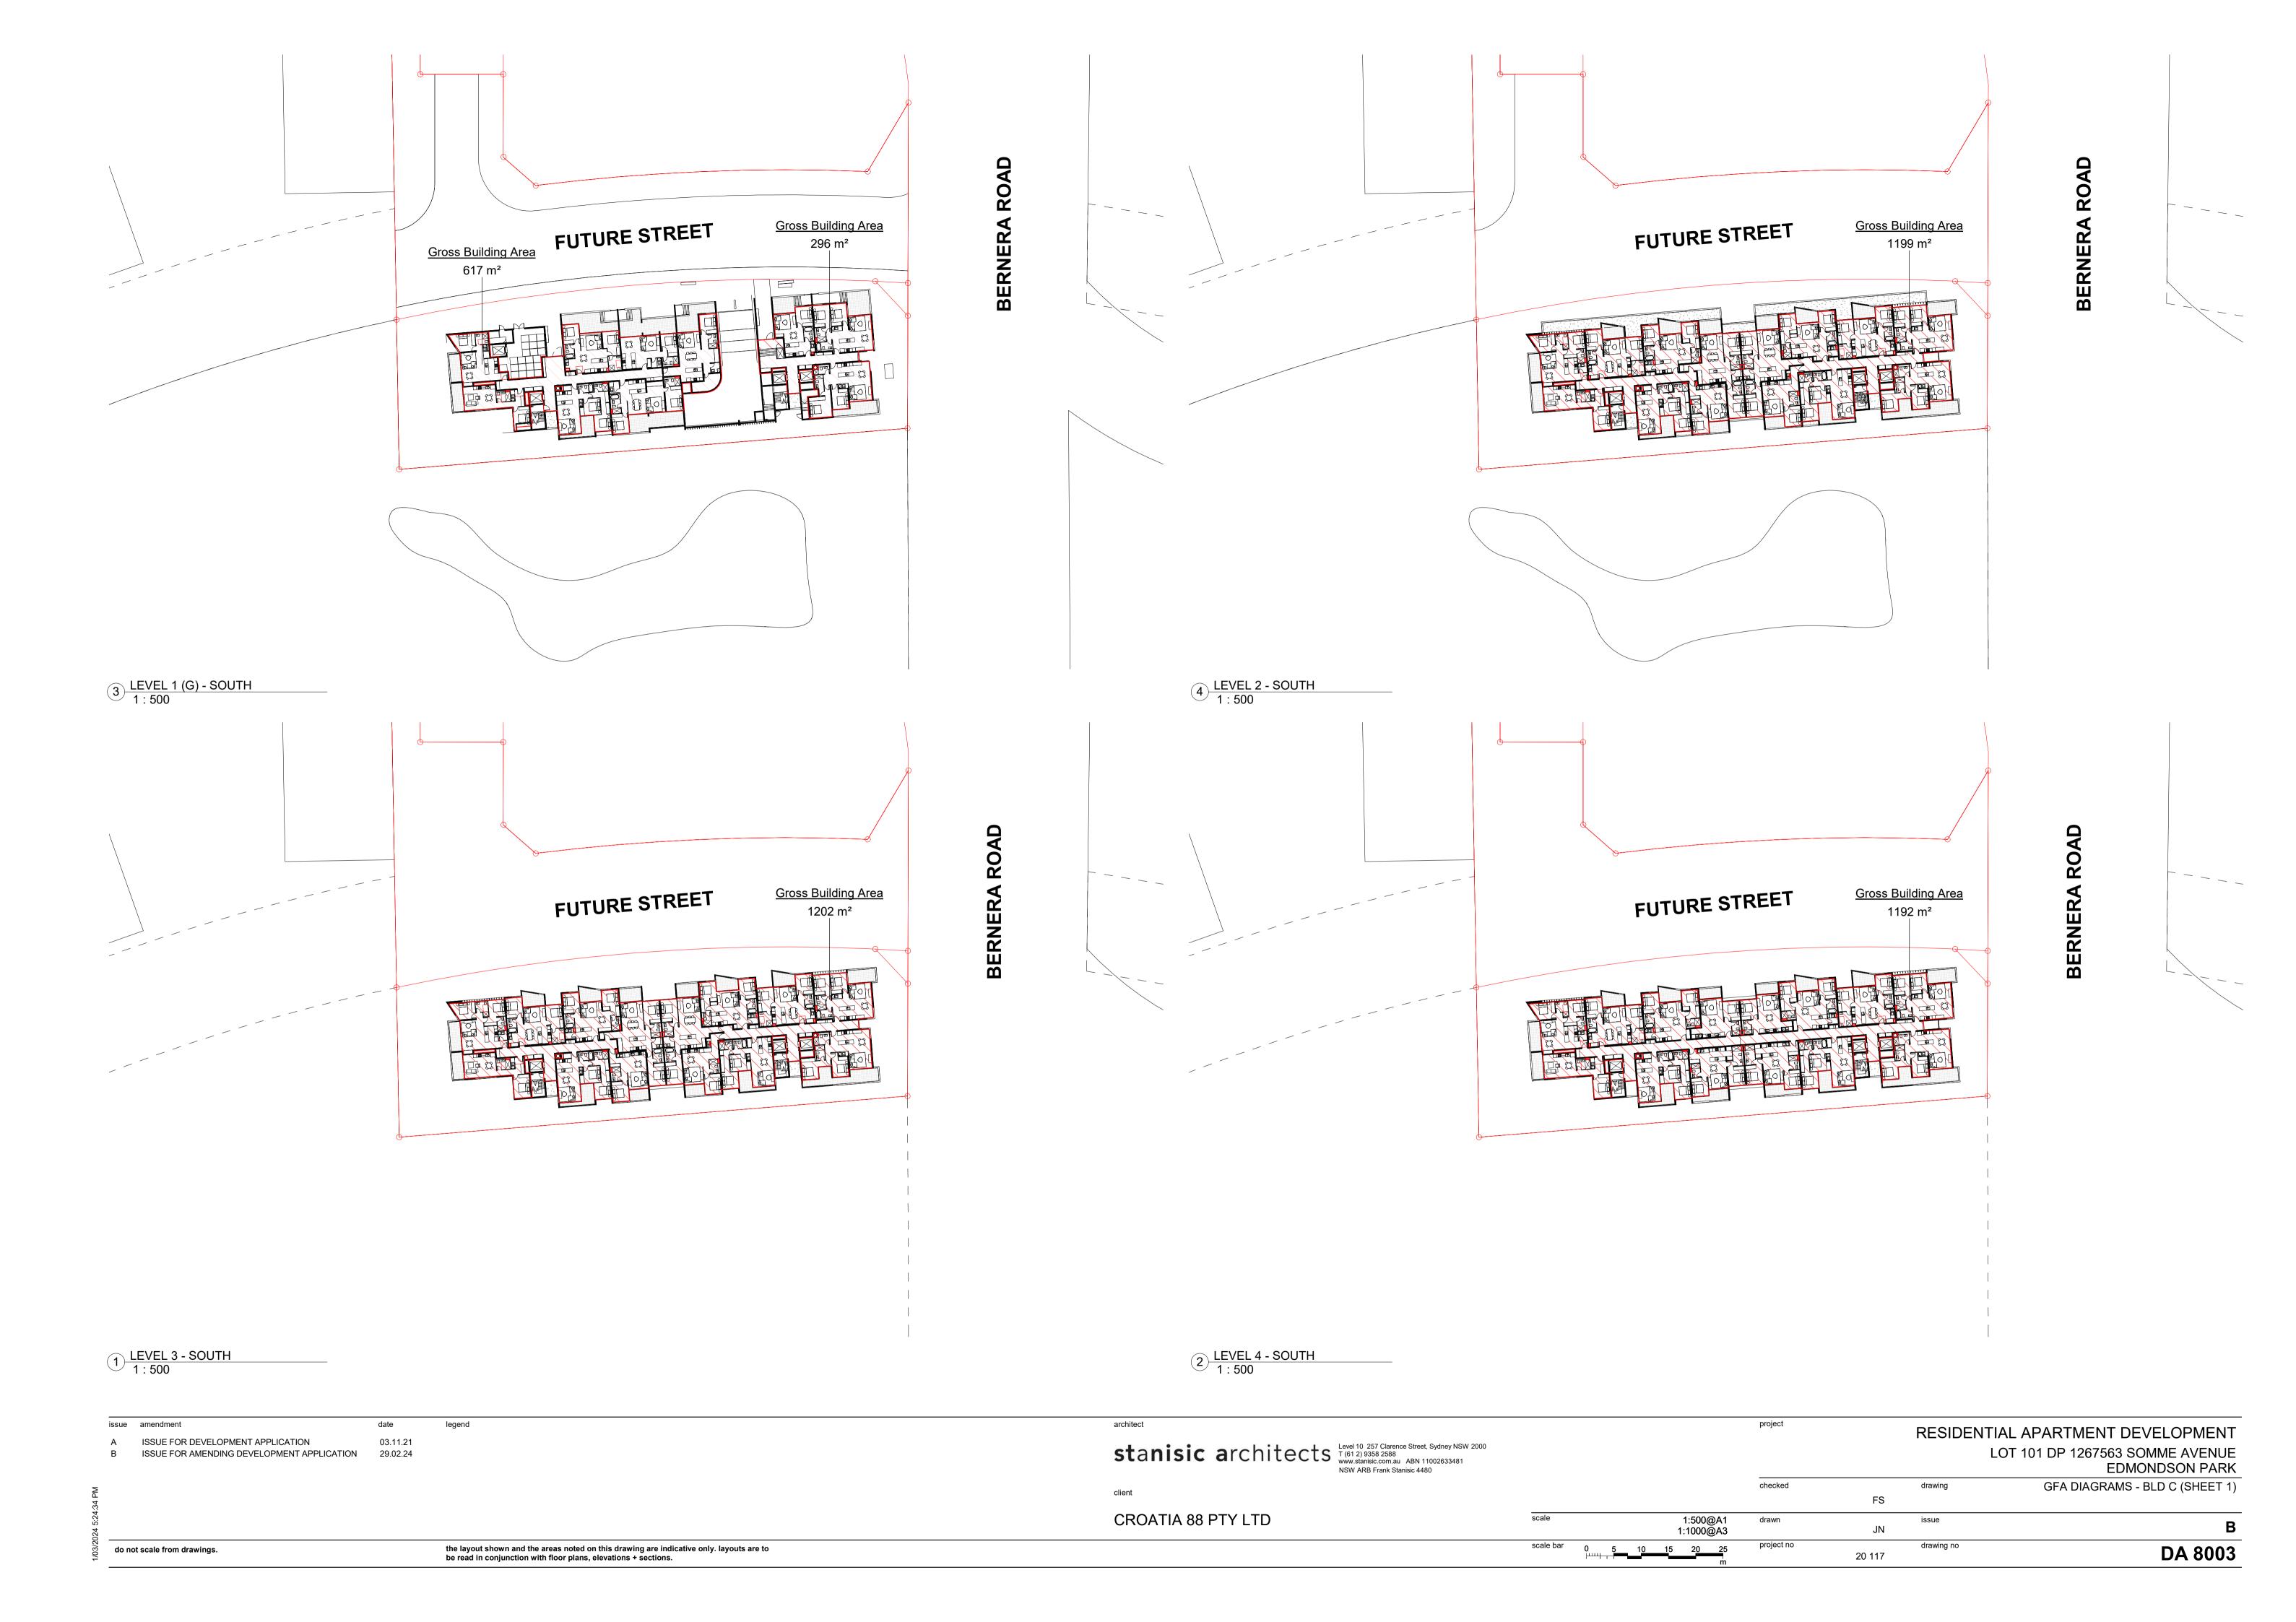























^ MAXIMUM HEIGHT OF BUILDING (SOUTH EAST VIEW)


^ MAXIMUM HEIGHT OF BUILDING (NORTH WEST VIEW)





APPROV	APPROVED BUILDING ELEMENT HEIGHT SCHEDULE								
APPROVED ITEM	APPROVED ELEMENT	APPROVED RL AT GROUND	APPROVED RL AT TOP	APPROVED HEIGHT OF ELEMENT (m)	APPROVED HEIGHT ABOVE MAXIMUM HOB (m)				
A	PLANT SCREEN	53.24	65.64	12.40	+0.40				
В	PLANT SCREEN	52.97	65.64	12.67	+0.67				
С	PLANT SCREEN	52.58	65.64	13.06	+1.06				
D	PARAPET	52.30	70.94	18.64	+6.64				
E	PARAPET	52.90	70.94	18.04	+6.04				
F	PLANT SCREEN	49.56	71.20	21.64	+0.64				
G	PLANT SCREEN	49.42	71.20	21.78	+0.78				
Н	LIFT OVERRUN	49.49	70.60	21.11	+0.11				

PROPOSED BUILDING ELEMENT HEIGHT SCHEDULE									
ITEM	ELEMENT	PROPOSED RL AT GROUND	PROPOSED RL AT TOP	PROPOSED HEIGHT OF ELEMENT (m)	PROPOSED HEIGHT ABOVE MAX HOB + 130% (m)				
Α	PLANT SCREEN	53.24	68.74	15.50	-0.10				
В	PLANT SCREEN	52.97	71.84	18.87	+3.27				
С	PLANT SCREEN	52.58	68.74	16.16	+0.56				
D	PARAPET	52.30	77.14	24.84	+9.24				
E	PARAPET	52.90	77.14	24.24	+8.64				
F	PLANT SCREEN	49.56	77.40	27.84	+0.54				
G	PLANT SCREEN	49.42	77.40	27.98	+0.98				
Н	LIFT OVERRUN	49.49	73.70	24.21	+3.09				

issue amendment A ISSUE FOR DEVELOPMENT APPLICATION B AMENDMENTS INCORPORATING DEP COMMENT P1 ISSUE PRELIMINARY SKETCH DESIGN	11.01.24	legend	architect stanisic architects Level 10 257 Clarence Street, Syd T (61 2) 9358 2588 www.stanisic.com.au ABN 11002 NSW ARB Frank Stanisic 4480	dney NSW 2000 2633481	project		AL APARTMENT DEVELOPMENT OT 101 DP 1267563 SOMME AVENUE EDMONDSON PARK
C ISSUE FOR AMENDING DEVELOPMENT APPLICA®	ATION 29.02.24		client		checked	drawing JN	MAXIMUM HOB 'HEIGHT BLANKET'
24 5:30:0			CROATIA 88 PTY LTD	scale	NTS drawn	issue SV	C
do not scale from drawings.		the layout shown and the areas noted on this drawing are indicative only. layouts are to be read in conjunction with floor plans, elevations + sections.		scale bar	project no	drawing no	DA 8013

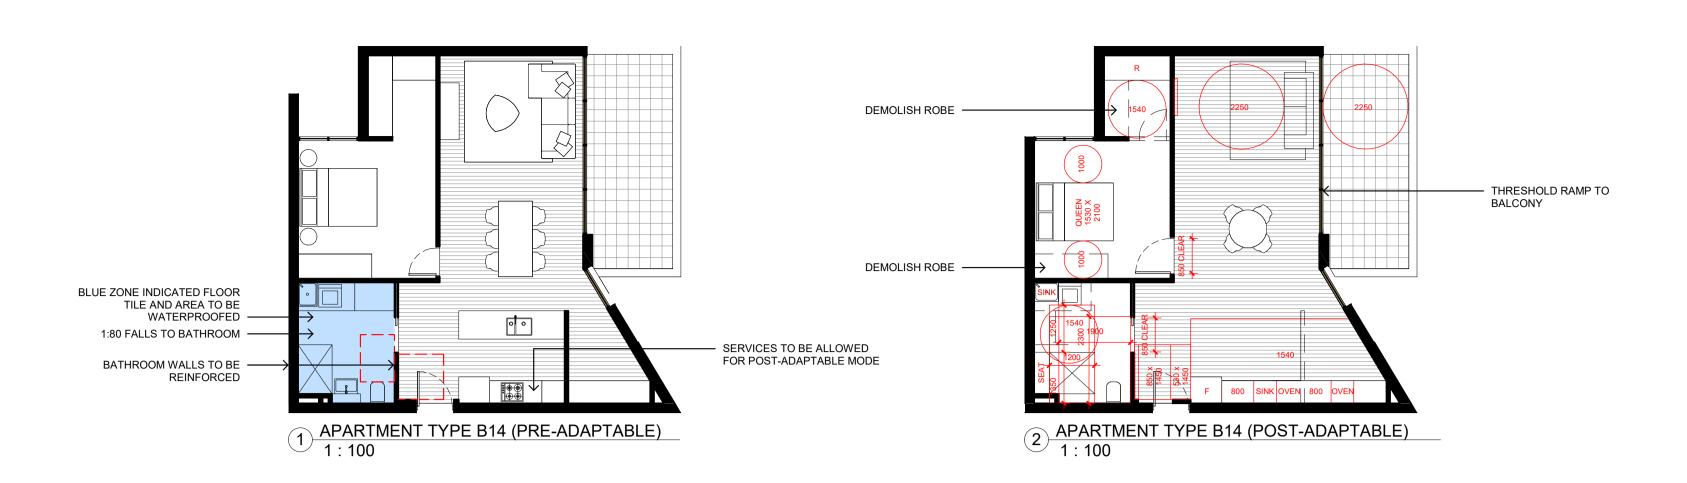

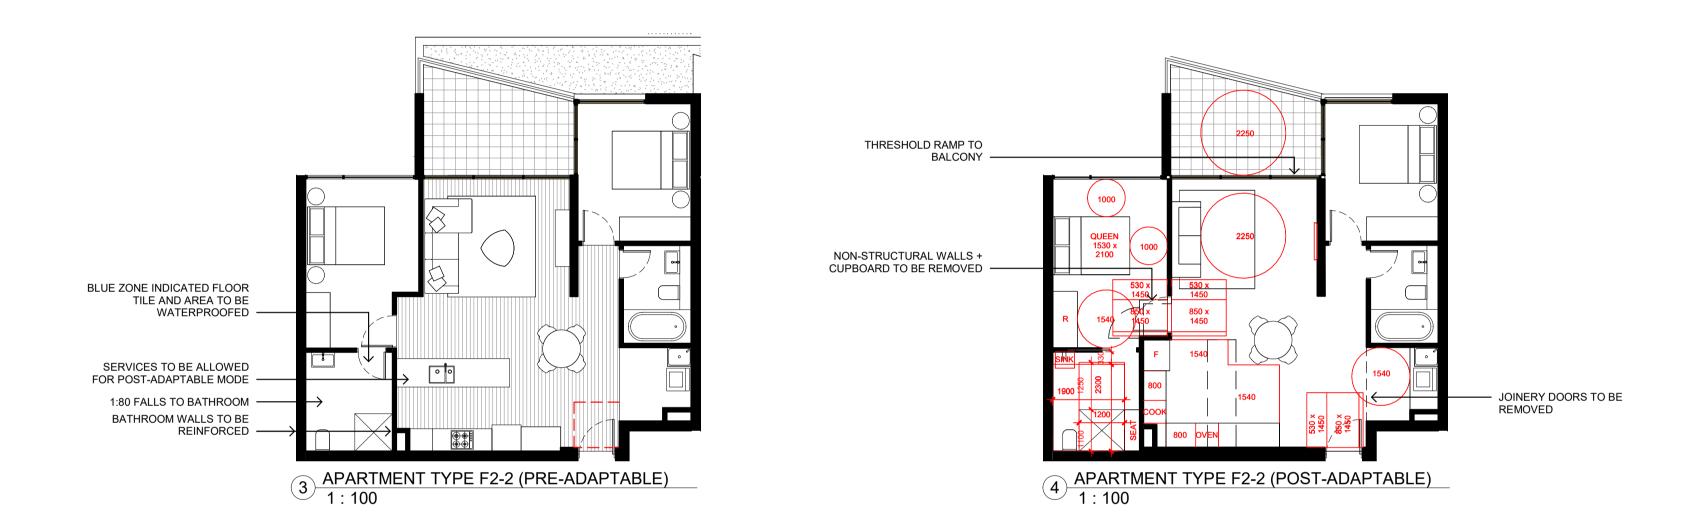

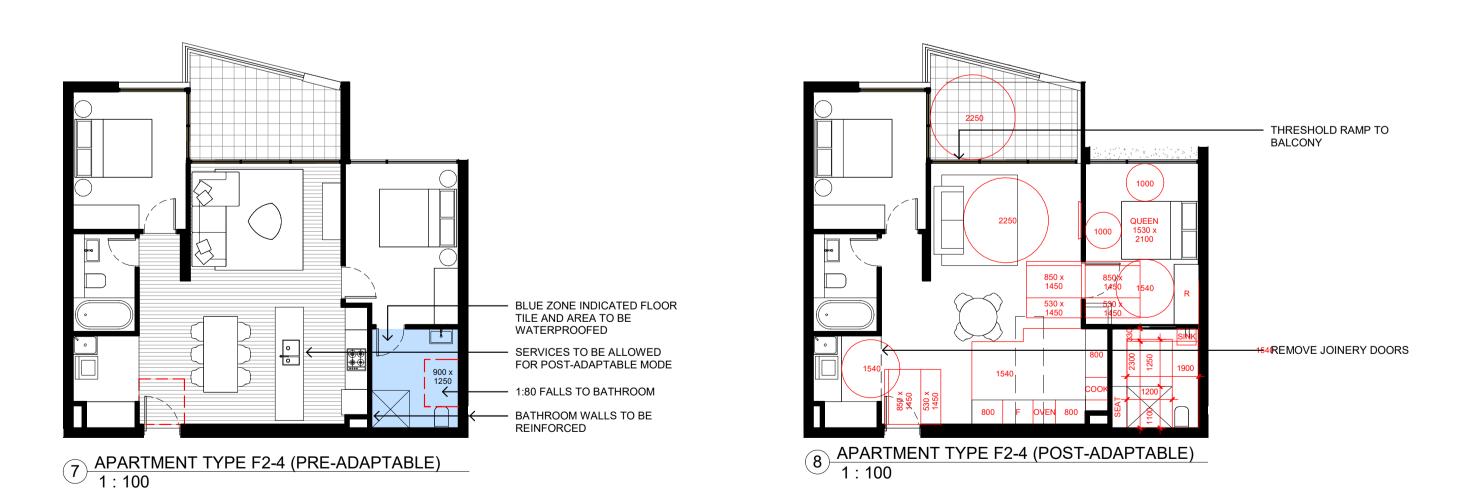

IDENTIFIED ON GENERAL ARRANGEMENT PLANS AS 'LIVE'

ACHIEVE 20% OF UNITS WITH SILVER LEVEL UNIVERSAL DESIGN FEATURES IN ACCORDANCE WITH THE APARTMENT DESIGN CLAUSE 4Q-1 LIVABLE UNITS TO ACHIEVE COMPLIANCE WITH THE LIVABLE HOUSING DESIGN GUIDE

1. LIVABLE UNITS

PROVIDE 'STEP FREE' DWELLING ENTRY PROVIDE 1200 X 1200MM CIRCULATION SPACE AT ENTRY DOOR INSIDE UNIT PROVIDE 820MM MIN CLEAR OPENING WIDTH AT ENTRY DOOR OF UNIT PROVIDE LATCH SIDE CLEARANCES AT ENTRY DOOR TO THE OUTSIDE OF THE UNIT IN ACCORDANCE WITH AS 1428.1

INTERIOR

PROVIDE 820MM CLEAR OPENING WIDTH TO ALL INTERNAL DOORS TO UNIT PROVIDE 1000MM CLEAR WIDTH TO ALL CORRIDORS LEVEL THRESHOLDS TO BE PROVIDED (5MM MAX STEP)

WET AREAS

PRIOR TO SHEETING WALLS, CONTRACTOR TO PROVIDE EVIDENCE OF WALL CONSTRUCTION TO SATISFY ASSESSORS REQUIREMENTS IN ACCORDANCE WITH LIVABLE PROVIDE 900 W X 1250 D CLEAR CIRCULATION IN FRONT OF TOILET PAN TO LIVABLE

LOCATE TOILET PAN IN CORNER OF LIVABLE BATHROOM TO ENABLE INSTALLATION OF

PROVIDE HOBLESS SHOWER TO LIVABLE BATHROOM LOCATE SHOWER IN CORNER OF LIVABLE BATHROOM TO ENABLE INSTALLATION OF GRABRAILS WALLS REQUIRED TO BE REINFORCED TO WITHSTAND 1100N MIN IN ALL DIRECTIONS

25MM THICK NOGGINGS (LHC FIG 6A) OR 12MM THICK SHEETING (LHC FIG 6B) TO BE PROVIDED TO WALLS OF WC 25MM THICK NOGGINGS (LHC FIG 7A) OR 12MM THICK SHEETING (LHC FIG 7B) TO BE PROVIDED TO WALLS SURROUNDING BATH

25MM THICK NOGGINGS (LHC FIG 8A) OR 12MM THICK SHEETING (LHC FIG 8B) TO BE PROVIDED TO WALLS SURROUNDING SHOWER BATHROOM TO HAVE SLIP RESISTANT AND HOBLESS SHOWER RECESS

2. ADAPTABLE UNITS (CLASS B - FIRST PRIORITY DESIRABLE - AS4299-1995)

IDENTIFIED ON GENERAL ARRANGEMENT PLANS AS 'ADAPT'

GENERAL

ADAPTALE UNITS TO ACHIEVE COMPLIANCE WITH AS4299, AS1428.1-5 EXTERIOR DOORS & WINDOWS TO HAVE THE CAPACITY FOR FITTING OF SECURITY SCREENS IN ACCORDANCE WITH AS4299 ALLOW FOR ALL DOOR HANDLES & RELATED HARDWARE TO BE OPERATED BY ONE HAND.

HANDLES & HARDWARE TO BE INSTALLED IN ACCORDANCE WITH AS4299 EXTERNAL PAVED SURFACES TO BE SLIP RESISTANT IN ACCORDANCE WITH AS3661.1 PROVIDE A CONTINUOUS ACCESSIBLE PATH OF TRAVEL FROM THE STREET FRONTAGE, VEHICLE PARKING, LETTERBOXES AND GARBAGE AREA TO COMPLY WITH AS 1428.1.

PROVIDE 850MM MIN CLEAR OPENING TO ENTRY DOOR OF UNIT IN PRE + POST

DOOR HANDLES AND HARDWARE TO COMPLY WITH AS1428.1

MIN ILLUMINATION LEVEL OF 300 LUX TO BE ACHIEVED

ADAPTABLE MODE PROVIDE LATCH SIDE CLEARANCES AT ENTRY DOOR TO THE OUTSIDE OF THE UNIT IN ACCORDANCE WITH AS 1428.1 IN PRE + POST ADAPTABLE MODE ALLOW FOR 'STEP FREE' DWELLING ENTRY IN ACCORDANCE WITH AS 1428.1 IN POST ADAPTABLE MODE

INTERNAL

PROVIDE 1000MM MIN CLEAR WIDTH TO ALL CORRIDORS IN PRE + POST ADAPTABLE

ALLOW FOR DOOR APPROACH CLEARANCES TO ADAPTABLE BEDROOM AND BATHROOM AS WELL AS ENTRY DOOR TO INSIDE OF UNIT IN POST ADAPTABLE MODE AS PER AS

INTERNAL DOORS IN POST ADAPTABLE MODE ARE TO HAVE A MINIMUM CLEAR OPENING LIGHT SWITCHED TO BE INSTALLED IN LINE WITH DOOR HANDLES AND IN ACCORDANCE

LOCATION AND HEIGHT OF GPO'S IN ACCORDANCE WITH AS4299 ALLOW FOR LINEN STORAGE TO HAVE ADJUSTABLE SHELVING WITH A MIN. WIDTH OF LIVING

ALLOW FOR 2250MM MIN CLEAR CIRCULATION SPACE TO LIVING ROOM IN POST ADAPTABLE MODE

ALLOW FOR 600MM WIDE LINEN CUPBOARD IN POST ADAPTABLE MODE WITH ADJUSTABLE SHELVING PROVIDE A MIN. OF 4 X DOUBLE GPO'S TO LIVING ROOM. HEIGHT TO BE IN ACCORDANCE

WITH AS4299 PROVIDE TELEPHONE OUTLET ADJACENT TO GPO IN LIVING ROOM PROVIDE 2 X TV ANTENNA OUTLETS ADJACENT TO GPO POSITIONED SO THAT VIEWING

FROM DINING & KITCHEN AREAS CAN BE ACHEIVED MIN ILLUMINATION LEVEL OF 300 LUX TO BE ACHIEVED

2. ADAPTABLE UNITS (CONT'D)

ALLOW 1540 X 2070MM CLEAR CIRCULATION SPACE AT THE END OF A QUEEN SIZE BED TO ADAPTABLE BEDROOM IN DIRECTION OF TRAVEL IN POST ADAPTABLE MODE ALLOW FOR 1000MM CLEAR WIDTH ON EACH SIDE OF BED IN POST ADAPTBLE MODE TO ADAPTABLE

ALLOW FOR 850MM CLEAR DOOR TO ADAPTABLE BEDROOM IN POST ADAPTABLE MODE ALLOW FOR QUEEN SIZED BED TO ADAPTABLE BEDROOM 1650 X 2100MM MIN IN POST ADAPTABLE MODE PROVIDE 2 X DOUBLE GPO'S ON WALL WHERE BEDHEAD IS TO BE LOCATED. PROVIDE A TELEPHONE OUTLET NEXT TO BED & ADJACENT DOUBLE GPO THAT IS CLOSEST TO THE DOOR.

PROVIDE A TV ANTENNA POINT & DOUBLE GPO ON OPPOSITE WALL TO BEDHEAD PROVIDE A TWO-WAY LIGHT SWITCH WITH ONE BEING LOCATED ABOVE THE BED MIN ILLUMINATION LEVEL OF 300 LUX TO BE ACHIEVED

ALLOW FOR 1550MM CIRCULATION SPACE BETWEEN KITCHEN BENCHES IN POST ADAPTABLE MODE ALLOW FOR 2.7M MIN WIDTH TO KITCHEN IN POST ADAPTABLE MODE ALLOW FOR A HEIGHT ADJUSTABLE (750-850MM HIGH) & 800MM WIDE MIN. WORK SURFACE IN POST ADAPTABLE MODE IN ACCORDANCE WITH AS4299. WORK SURFACE TO BE LOCATED ADJACENT REFRIDGERATOR, OVEN & COOKTOP. ALSO ALLOW FOR THE REMOVAL OF CABINETS ALLOW FOR WALL OVEN IN POST ADAPTABLE MODE

ALLOW FOR CAPPED OFF SERVICES IF THE LOCATION OF FIXTURES IS DIFFERENT IN THE PRE + POST ADAPTABLE MODES. ALLOW FOR ADJUSTABLE SINK HEIGHT BETWEEN 750MM - 850MM IN POST ADAPTABLE MODE. ALSO ALLOW FOR THE REMOVAL OF CABINETS UNDER THE SINK.

ALLOW FOR MIXER TAPSET WITHIN 300MM FROM THE FRONT OF SINK IN POST ADAPTABLE MODE. TAP SETS SHOULD ALSO HAVE EITHER CAPSTAN OR LEVER HANDLES LOCATE SINK WITHIN 150MM OF FRONT OF BENCH IN POST ADAPTABLE MODE DEPTH OF SINK TO BE 150MM MAX.

PROVIDE GPO IN ACCORDANCE WITH AS1428.1 + AT LEAST ONE GPO WITHIN 300MM FROM THE FRONT OF BENCH IN POST ADAPTABLE MODE INSTALL A THERMOSTATIC MIXING VALVE IN ACCORDANCE WITH AS4299

COOKTOPS TO BE INSTALLED WITH RAISED CROSS BARS & WITH ISOLATING SWITCHES OR GAS STOP VALVES IN ACCORDANCE WITH AS4299 KITCHEN AREA TO HAVE A MIN ILLUMINATION LEVEL OF 300 LUX WITH A MIN. OF 550 LUX PROVIDED OVER WORK SURFACES IN ACCORDANCE WITH AS4299

PROVIDE D-PULL HANDLES LOCATED AT THE TOP OF BELOW BENCH CUPBOARDS AND AT THE BOTTOM OF OVERHEAD CUPBOARDS IN ACCORDANCE WITH AS4299 SLIP RESISTANT FLOORING TO BE PROVIDED IN ACCORDANCE WITH AS4299

PROVIDE AT LEAST 1 X GPO TO BE REACHED WITHIN 300MM FROM THE FRONT OF A WORK SURFACE. LOCATE GPO FOR REFRIDGERATOR SO THAT IT IS EASILT REACHABLE IN ITS OPERATING POSITION.

ALLOW FOR A HOBLESS SHOWER RECESS WITH CLEARANCES IN ACCORDANCE WITH AS1428.1 IN POST

ADAPTABLE MODE ALLOW PROVISION FOR GRABRAILS IN SHOWER RECESS & AROUND TOILET PAN TO BE INSTALLED IF REQUIRED IN ACCORDANCE WITH AS1428.1 IN POST ADAPTABLE MODE

ALLOW FOR SINK WITH CLEARANCE IN ACCORDANCE WITH AS1428.1 IN POST ADAPTABLE MODE ALLOW FOR TOILET PAN WITH CLEARANCES IN ACCORDANCE WITH AS1428.1 AND LOCATE IN CORNER OF BATHROOM FOR THE INSTALLATION OF GRABRAILS IN POST ADAPTABLE MODE INSTALL SHOWER HEAD, TAPS & RECESSED SOAP HOLDER IN ACCORDANCE WITH AS1428.1 + AS4299. ENSURE WALL OUTLET FOR SHOWER HEAD INCLUDES A BACK FLOW PREVENTION DEVICE IN THE PRE ADAPTATION STAGE.

ALLOW FOR DOUBLE GPO ADJACENT TO MIRROR IN POST ADAPTABLE MODE PROVIDE CAPPED-OFF SERVICES TO WET AREAS IF THE LOCATION OF SERVICES IS DIFFERENT IN PRE + POST ADAPTABLE MODES (REFER TO CONCRETE SETOUT DRAWINGS). THESE AREAS ARE TO HAVE TILING DONE AT THE PRE ADAPTATION STAGE.

SLIP RESISTANT FLOOR SURFACES TO BE PROVIDED IN ACCORDANCE WITH AS3661.1 ALL WATERPROOFING TO BATHROOM TO COMPLY WITH AS3740 ALLOW FOR TAP SETS IN BATHROOM & LAUNDRY TO HAVE EITHER CAPSTAN OR LEVER HANDLES & A THERMOSTATIC MIXING VALVE TO BE INSTALLED.

ALLOW FOR A WALL CABINET WITH A LIGHT ABOVE AND A DOUBLE GPO ADJACENT THE MIRROR BATHROOM & LAUNDRY TO HAVE A MIN ILLUMINATION LEVEL OF 300 LUX WITH A MIN. OF 550 LUX PROVIDED FOR TASK LIGHTING IN ACCORDANCE WITH AS4299 ALLOW FOR 1550MM CIRCULATION SPACE IN FRONT OF LAUNDRY APPLIANCES IN POST ADAPTABLE MODE ALLOW FOR AN AUTOMATIC WASHING MACHINE & DRIER TO BE INSTALLED WITH AT LEAST 1 X DOUBLE


DOOR HANDLES ARE TO COMPLY WITH AS1428.1-2009 DOOR HARDWARE TO BE OPERABLE WITH ONE HAND


drawing no

20 117


ALL ABOVE NOTES ARE EXTRACTED FROM RELEVANT DOCUMENTS. FOR FULL GUIDELINE AND REQUIREMENTS, PLEASE REFER TO AS1428.1/AS1428.2/AS4299/ LIVABLE HOUSING DESIGN GUIDELINES/LOCAL DCP.

issue amendment legend RESIDENTIAL APARTMENT DEVELOPMENT ISSUE FOR DEVELOPMENT APPLICATION 03.11.21 stanisic architects Level 10 257 Clarence Street, Sydney NSW 2000 T (61 2) 9358 2588 www.stanisic.com.au ABN 11002633481 LOT 101 DP 1267563 SOMME AVENUE ISSUE FOR AMENDING DEVELOPMENT APPLICATION 29.02.24 **EDMONDSON PARK** NSW ARB Frank Stanisic 4480 ADAPTABLE + LIVABLE ACCOMMODATION checked drawing DIAGRAMS (SHEET 1) FS CROATIA 88 PTY LTD scale 1:100@A1 drawn issue JN 1:200@A3

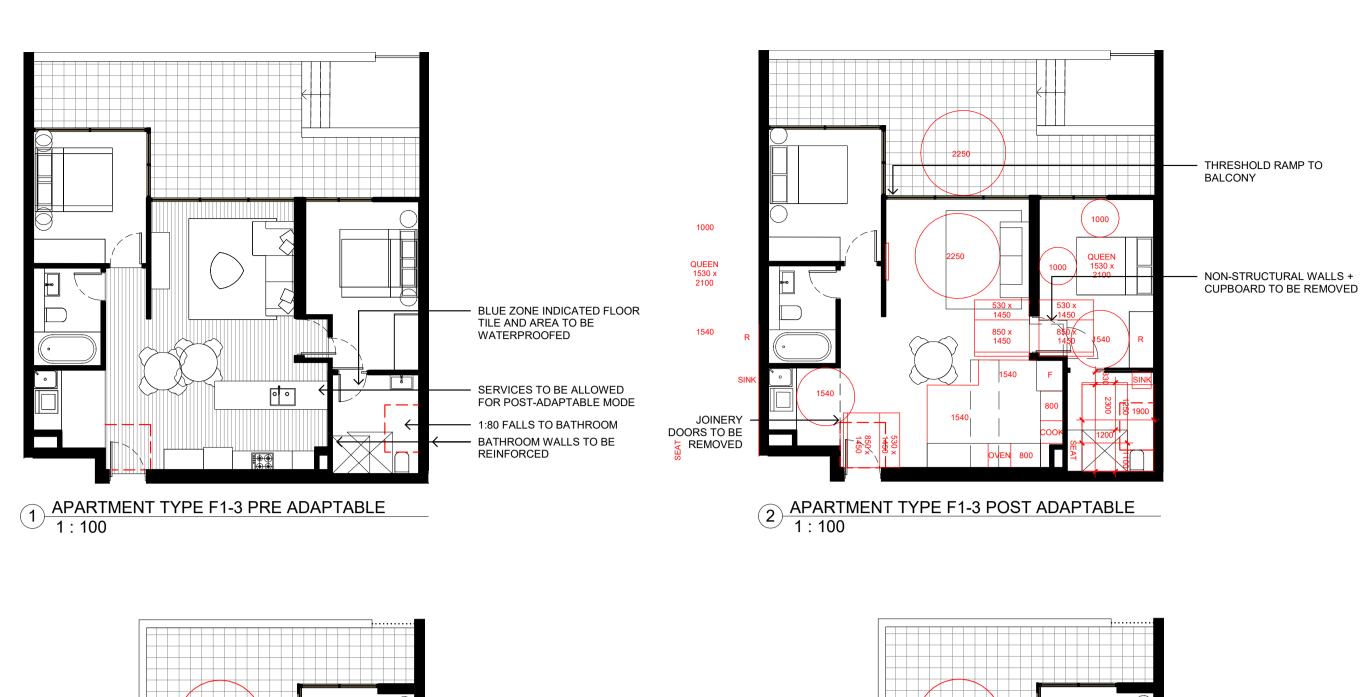


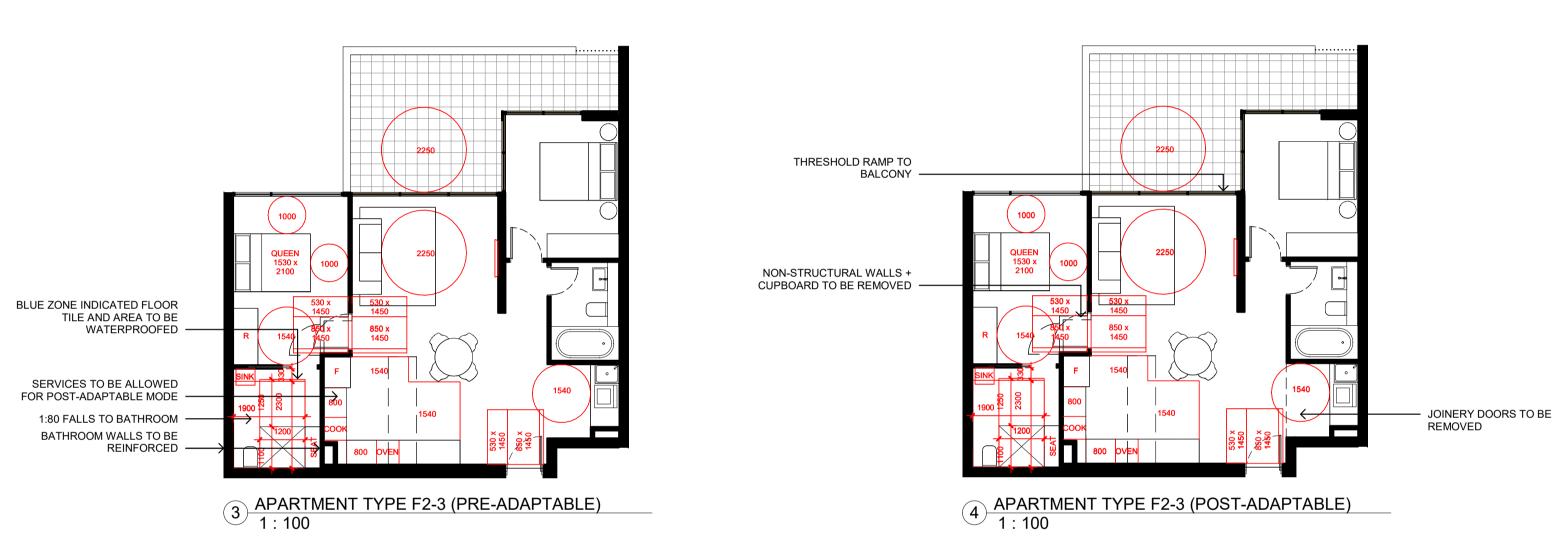

issue A B	amendment ISSUE FOR DEVELOPMENT APPLICATION ISSUE FOR AMENDING DEVELOPMENT APPLICATION	date 03.11.21 29.02.24	legend	stanisic architects Level 10 257 Clarence Street, Sydney NSW 2000 T (61 2) 9358 2588 www.stanisic.com.au ABN 11002633481 NSW ARB Frank Stanisic 4480			project		RESIDEI	NTIAL APARTMENT DEVELOPMENT LOT 101 DP 1267563 SOMME AVENUE EDMONDSON PARK
19 PM				client			checked	FS	drawing	ADAPTABLE + LIVABLE ACCOMMODATION DIAGRAMS (SHEET 2)
)24 5:30:				CROATIA 88 PTY LTD	scale	1:100@A1 1:200@A3	drawn	JN	issue	В
1/03/20 op	o not scale from drawings.		the layout shown and the areas noted on this drawing are indicative only. layouts are to be read in conjunction with floor plans, elevations + sections.		scale bar	0 1 2 3 4 5 m	project no	20 117	drawing no	DA 8015

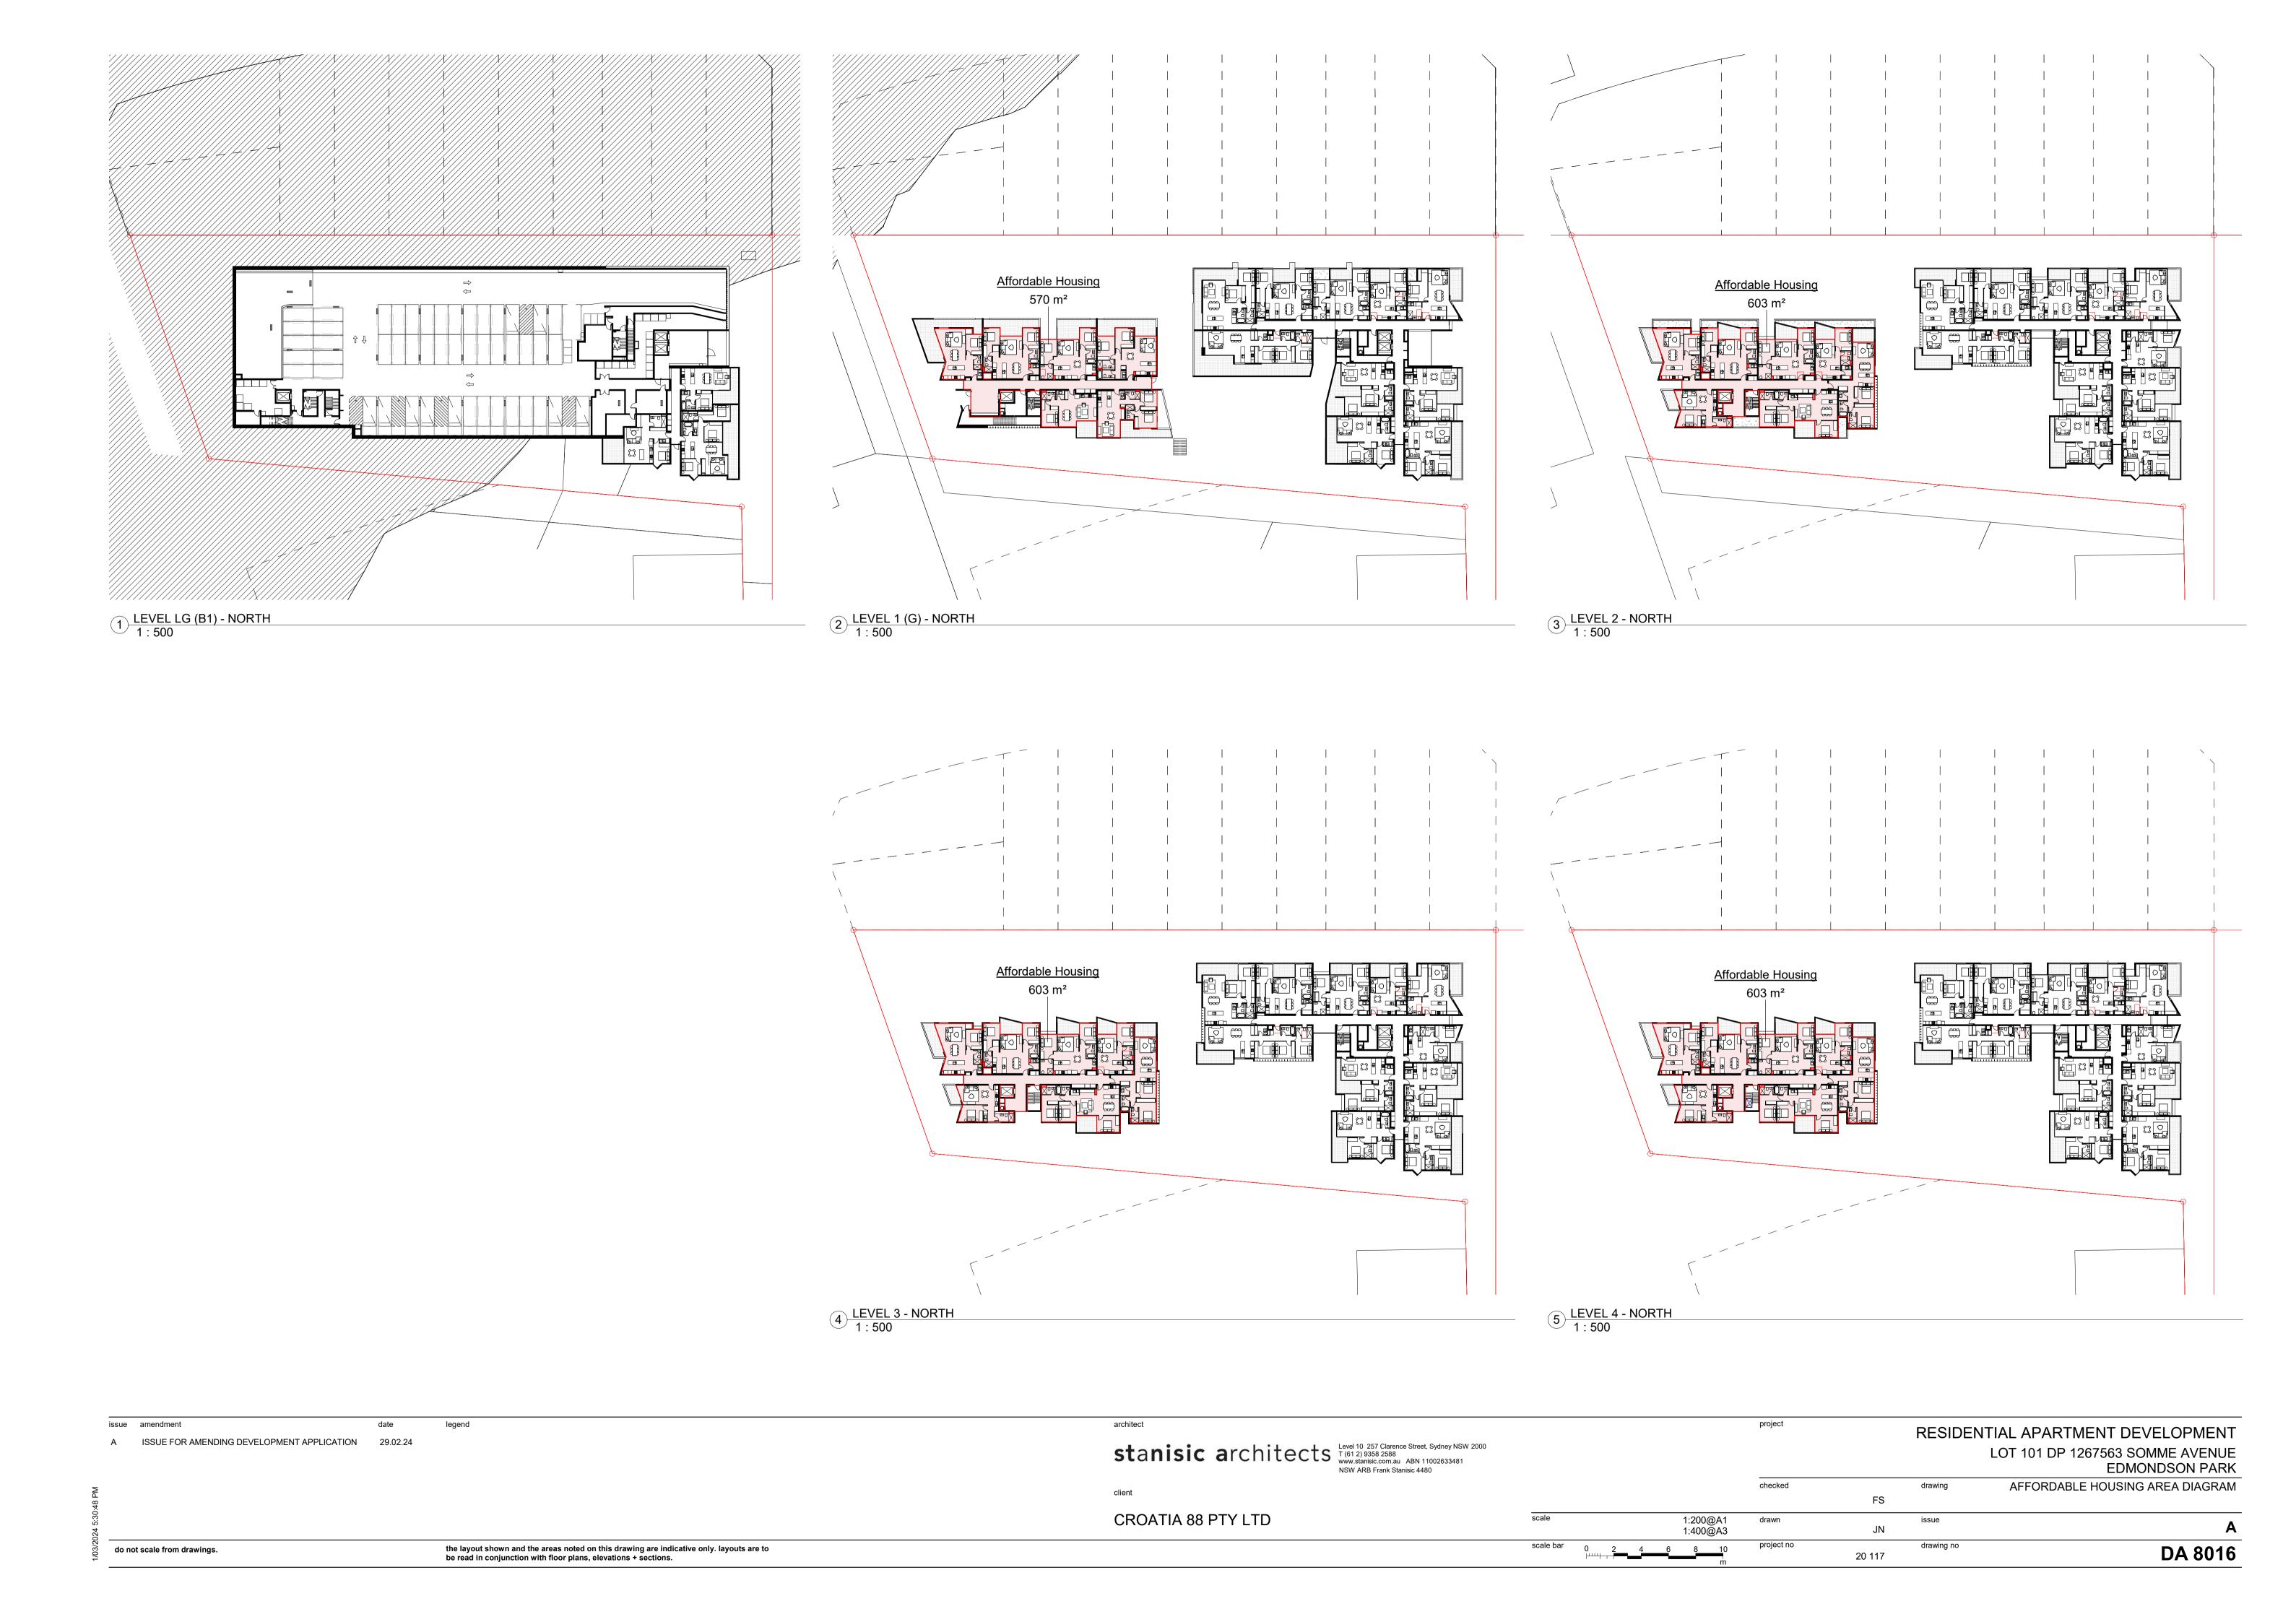



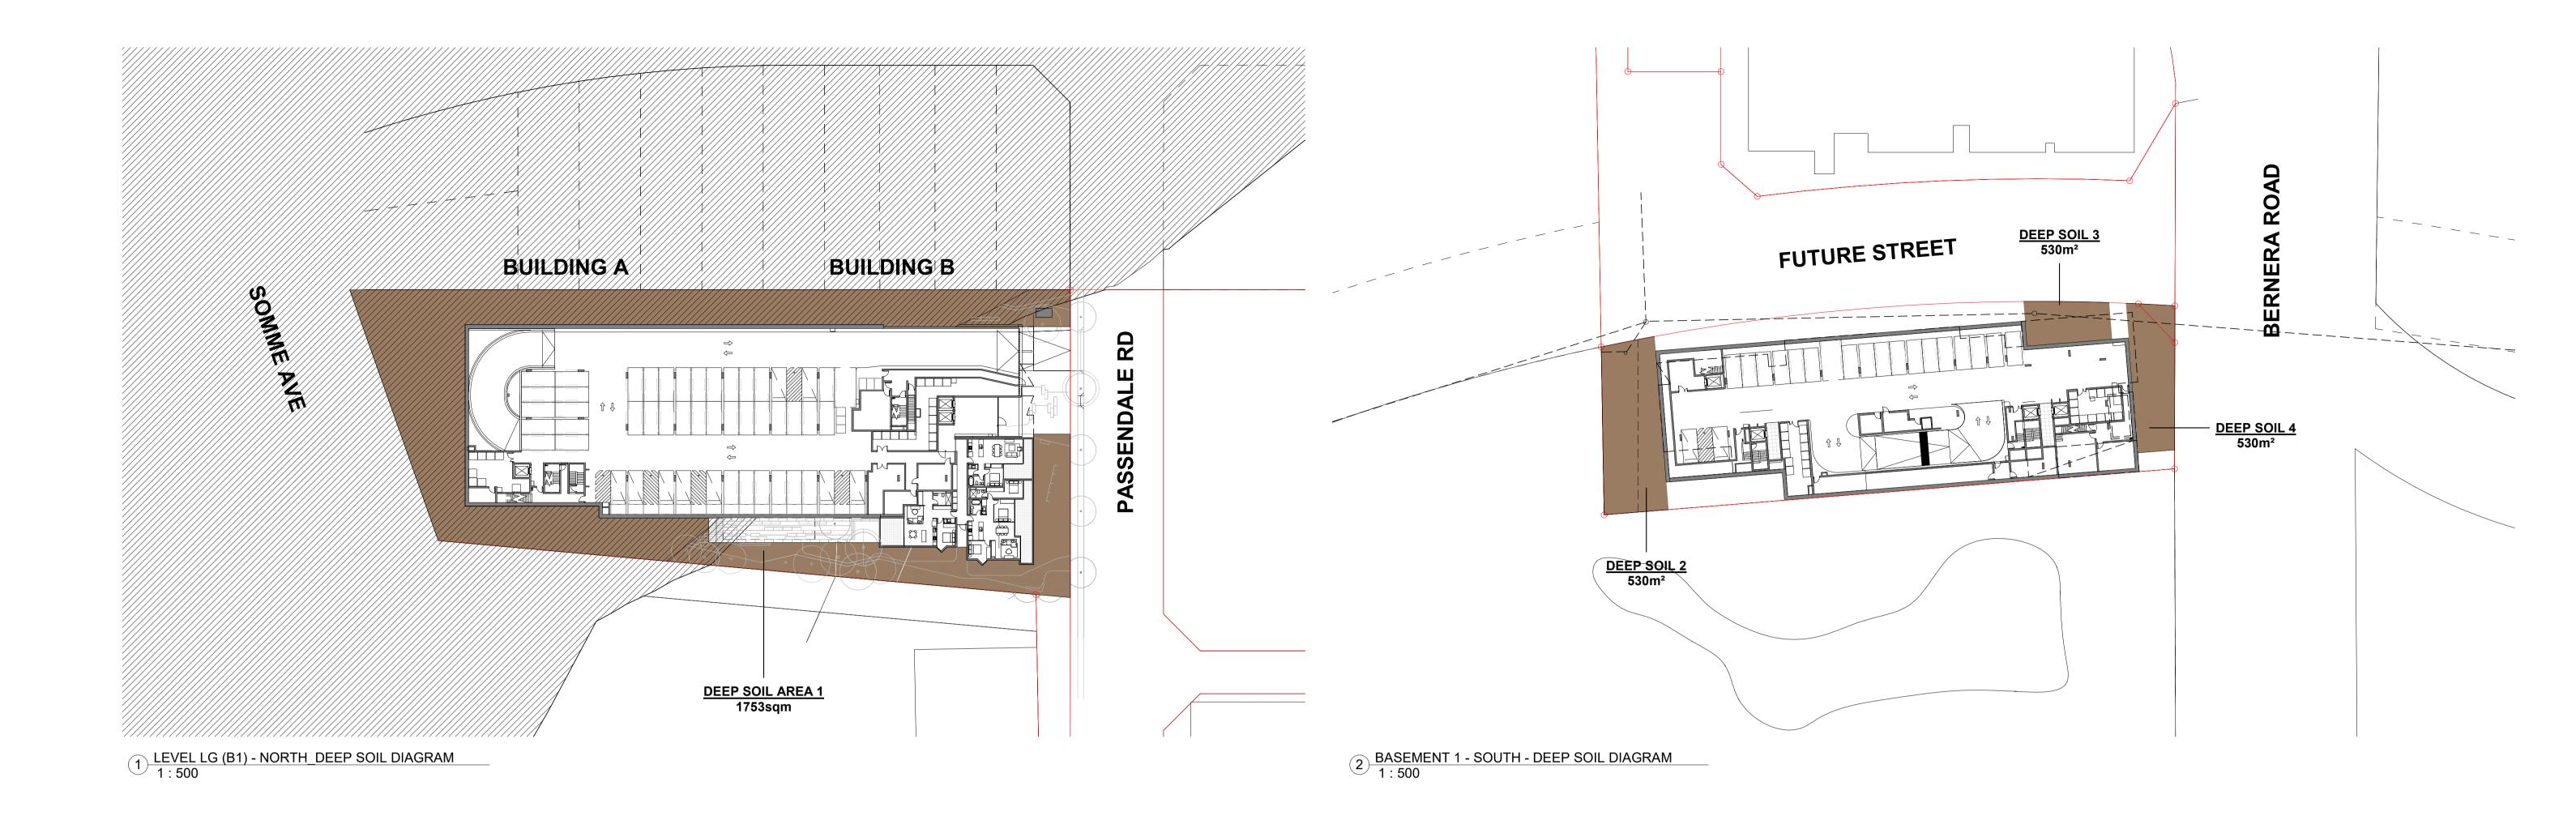

Apartment Design Guide

Objective 3E-1 - Deep soil zones

Area of soil within a development that are unimpeded by buildings or structures above and below ground and have a minimum dimension of 6m. Deep soil zones exclude basement car parks, services, swimming pools, tennis courts and impervious surfaces including car parks, driveways and roof areas

do not scale from drawings.		the layout shown and the areas noted on this drawing are indicative only. layouts are to be read in conjunction with floor plans, elevations + sections.		scale bar 0 μω	5 10 15 20 25	project no	20 117	drawing no	DA 8018
024 5:31			CROATIA 88 PTY LTD	scale	1:500@A1 1:1000@A3	drawn	Author	issue	Α
7.8 PM			client			checked	Checker	drawing	DEEP SOIL AREA DIAGRAMS
A ISSUE FOR AMENDING DEVELOPMENT APPLICATION	29.02.24		stanisic architects Level 10 257 Clarence T (61 2) 9358 2588 www.stanisic.com.au NSW ARB Frank Stani						L APARTMENT DEVELOPMENT T 101 DP 1267563 SOMME AVENUE EDMONDSON PARK
issue amendment	date	legend	architect			project		DECIDENTIA	I ADADTMENT DEVELODMENT





EXTERNAL MATERIALS, FINISHES + COLOUR BOARD

Residential Apartment Development **Lot 101 DP 1267563 Somme Avenue Edmondson Park NSW**

ISSUE B

DESCRIPTION

- MASONRY, PAINT FINISH, DULUX, GREY PEBBLE OR SIMILAR
 MASONRY, PAINT FINISH, DULUX, MALAY GREY OR SIMILAR
 MASONRY, PAINT FINISH, DULUX, MUD PACK OR SIMILAR
 MASONRY, VERTICAL GROOVES, DULUX, GREY PEBBLE OR SIMILAR
 MASONRY, PAINT FINISH, COLOUR TO MATCH PC1
 MASONRY, PAINT FINISH, COLOUR TO MATCH PC2
 FACEBRICK, DRY PRESSED, BOWRAL BRICKS, BOWRAL BLUE
 ALUMINIUM FRAMED WINDOWS + DOORS, DULUX, ELECTRO RANGE, DARK BRONZE
 ALUMINIUM FRAMED WINDOWS + DOORS, DULUX, ELECTRO RANGE, MEDIUM BRONZE
 ALUMINIUM BLADES, DULUX, ELECTRO RANGE, MEDIUM BRONZE
 ALUMINIUM BATTENS, DULUX, ELECTRO RANGE, MEDIUM BRONZE
 ALUMINIUM PLANT SCREEN, DULUX, ELECTRO RANGE, MEDIUM BRONZE
 CLEAR GLASS, VIRIDIAN, BRONZE
 TRANSLUCENT GLASS, VIRIDIAN, LUMINA CLOUD, CLEAR

- 15. TRANSLUCENT GLASS, VIRIDIAN, LUMINA CLOUD, CLEAR
 16. TRANSLUCENT GLASS, VIRIDIAN, LUMINA CLOUD, GREY
 17. ALUMINIUM PICKET BALUSTRADE, DULUX ELECTRO RANGE, MEDIUM BRONZE

ABBREVIATION

PC1 PC2 PC3 AL5 GL1 GL3

BUILDING A

			8	14, 16
	9, 10, 11 12, 17			
7	1, 4, 5	3	2, 6	15

stanisic architects



EXTERNAL MATERIALS, FINISHES + COLOUR BOARD

Residential Apartment Development Lot 101 DP 1267563 Somme Avenue Edmondson Park NSW

ISSUE B

PC1 PC2 PC3 PC4 MASONRY, PAINT FINISH, DULUX, GREY PEBBLE OR SIMILAR MASONRY, PAINT FINISH, DULUX, MALAY GREY OR SIMILAR MASONRY, PAINT FINISH, DULUX, MUD PACK OR SIMILAR MASONRY, VERTICAL GROOVES, DULUX, GREY PEBBLE OR SIMILAR MASONRY, PAINT FINISH, COLOUR TO MATCH PC1 MASONRY, PAINT FINISH, COLOUR TO MATCH PC2 P01 7. FACEBRICK, DRY PRESSED, BOWRAL BRICKS, BOWRAL BLUE 8. ALUMINIUM FRAMED WINDOWS + DOORS, DULUX, ELECTRO RANGE, DARK BRONZE 9. ALUMINIUM FRAMED WINDOWS + DOORS, DULUX, ELECTRO RANGE, MEDIUM BRONZE 10. ALUMINIUM BLADES, DULUX, ELECTRO RANGE, MEDIUM BRONZE 11. ALUMINIUM BATTENS, DULUX, ELECTRO RANGE, MEDIUM BRONZE 12. ALUMINIUM PLANT SCREEN, DULUX, ELECTRO RANGE, MEDIUM BRONZE 13. CLEAR GLASS, VIRIDIAN, TINTED, DARK GREY AL3 AL4 AL5 GL1 GL2 GL3 GL4 BAL1 14. CLEAR GLASS, VIRIDIAN, TINTED, DARK GREY 15. TRANSLUCENT GLASS, VIRIDIAN, LUMINA CLOUD, CLEAR 16. TRANSLUCENT GLASS, VIRIDIAN, LUMINA CLOUD, GREY 17. ALUMINIUM PICKET BALUSTRADE, DULUX ELECTRO RANGE, MEDIUM BRONZE

BUILDING B

		8	3	14, 16
		9, 10 12,	0, 11 , 17	13
7	1, 4, 5	3	2, 6	15

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EXTERNAL MATERIALS, FINISHES + COLOUR BOARD

Residential Apartment Development Lot 101 DP 1267563 Somme Avenue Edmondson Park NSW

ISSUE B

DESCRIPTION

- MASONRY, PAINT FINISH, DULUX, GREY PEBBLE OR SIMILAR MASONRY, PAINT FINISH, DULUX, MALAY GREY OR SIMILAR
- MASONRY, PAINT FINISH, DULUX, MUD PACK OR SIMILAR
 MASONRY, VERTICAL GROOVES, DULUX, GREY PEBBLE OR SIMILAR
 MASONRY, PAINT FINISH, COLOUR TO MATCH PC1
 MASONRY, PAINT FINISH, COLOUR TO MATCH PC2

- 7. FACEBRICK, DRY PRESSED, BOWRAL BRICKS, BOWRAL BLUE
 8. ALUMINIUM FRAMED WINDOWS + DOORS, DULUX, ELECTRO RANGE, DARK BRONZE
 9. ALUMINIUM FRAMED WINDOWS + DOORS, DULUX, ELECTRO RANGE, MEDIUM BRONZE
 10. ALUMINIUM BLADES, DULUX, ELECTRO RANGE, MEDIUM BRONZE
 11. ALUMINIUM BATTENS, DULUX, ELECTRO RANGE, MEDIUM BRONZE
 12. ALUMINIUM PLANT SCREEN, DULUX, ELECTRO RANGE, MEDIUM BRONZE
 13. CLEAR GLASS, VIRIDIAN, TINTED, DARK GREY

- 14. CLEAR GLASS, VIRIDIAN, TINTED, DARK GREY
 15. TRANSLUCENT GLASS, VIRIDIAN, LUMINA CLOUD, CLEAR
 16. TRANSLUCENT GLASS, VIRIDIAN, LUMINA CLOUD, GREY
 17. ALUMINIUM PICKET BALUSTRADE, DULUX ELECTRO RANGE, MEDIUM BRONZE

ABBREVIATION

PC1 PC2 PC3 PC4 P01 AL3 AL4 AL5 GL1 GL2 GL3 GL4 BAL1

BUILDING C

		8	3	14, 16
		9, 10 12,	0, 11 , 17	13
7	1, 4, 5	3	2, 6	15

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